2022 EXTERIOR FACADE REPAIR PROJECT - P

CITYVIEW CO-OP 1811 ELLIOT AVENUE SOUTH MINNEAPOLIS, MN

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GENERAL NOTES

- CONTRACTOR IS RESPONSIBLE FOR FIELD VERIFYING ALL DIMENSIONS AND EXISTING CONDITIONS PRIOR TO BIDDING AND/OR PERFORMING WORK.
- PRIOR TO DEMO, CONTRACTOR SHALL PROVIDE OWNER WITH 24 HOURS NOTICE AND SHALL ERECT BARRIERS TO PREVENT PEDESTRIAN TRAFFIC BENEATH THE WORK AREA.
- IN THE CASE OF AMBIGUITIES, DISCREPANCIES OR IRREGULARITIES IN THE DRAWINGS, SPECIFICATIONS, MANUFACTURER'S INSTRUCTIONS, SITE CONDITIONS OR APPLICABLE CODES AND STANDARDS, CONTRACTOR SHALL REQUEST CLARIFICATION FROM ENGINEER BEFORE PROCEEDING.
- CONTRACTOR SHALL PROVIDE, ERECT, AND MAINTAIN TEMPORARY PEDESTRIAN WALKWAY PROTECTION ON ALL WALKWAYS BELOW WHICH OVERHEAD WORK IS OCCURRING. ALL BUILDING EGRESSES SHALL REMAIN OPEN & PROTECTED THROUGH THE FULL DURATION OF THE PROJECT.
- CONTRACTOR SHALL LIMIT STAGING AND STORAGE AREAS TO THOSE APPROVED BY OWNER. CONTRACTOR SHALL PROTECT ALL PORTIONS OF THE BUILDING, LANDSCAPING, AND PROPERTY IN STAGING AND STORAGE AREAS, AND SHALL REPAIR ALL DAMAGED CAUSED BY STAGING AND STORAGE TO OWNER'S SATISFACTION.
- CONTRACTOR SHALL PROVIDE ENGINEER WITH ACCESS TO THE BUILDING VIA CONTRACTOR'S SCAFFOLDING AND RIGGING AS NEEDED THROUGHOUT THE DURATION OF WORK.

GENERAL SCOPE AND CODE NOTES:

- THE REPAIR SCOPE IDENTIFIED WITHIN THESE DRAWINGS IS BASED ON OBSERVATIONS AND INSPECTIONS REFERENCED WITHIN THE ENCOMPASS REPORT DATED JUNE 25, 2020. REPAIR SCOPE HAS BEEN DEFINED WITHIN THESE DOCUMENTS BASED ON THE INTENT OF THE OWNER TO PERFORM PHASE II REPAIRS IN 2022.
- REPAIRS PERFORMED IN 2022 TO BE ACCORDANCE WITH THE 2020 MINNESOTA BUILDING CODE. IF REPAIRS OCCUR AFTER 2022, OWNER TO NOTIFY ENGINEER OF RECORD OF INTENT TO PERFORM REPAIRS AND REQUEST AN APPLICABLE CODE REVIEW OF PROPOSED REPAIRS PRIOR TO PERFORMING (FUTURE REPAIRS).
- THESE CONDITIONS ARE LIKELY TO CHANGE OVER TIME. IT IS LIKELY THAT 4. THE EXTENT OF REPAIRS AND REPAIR SCOPE WILL EXPAND OVER TIME. IF THE OWNER DOES NOT PERFORM THESE REPAIRS OR PARTIALLY PERFORMS THESE REPAIRS IN 2022, IT IS RECOMMENDED THAT REMAINING CONDITIONS BE RE-INSPECTED AND THE REPAIR SCOPE BE REVIEWED BY THE ENGINEER OF RECORD AND CONTRACTOR FOR ACCURACY PRIOR TO PERFORMING FUTURE REPAIRS (REPAIRS PERFORMED AFTER 2022).
- OWNER AND/OR OWNERS REPRESENTATIVE TO NOTIFY ENGINEER OF RECORD IF EXISTING CONDITIONS HAVE CHANGED OR IF CONTINUED FACADE MOVEMENT IS SUSPECTED PRIOR TO PERFORMING OR DURING REPAIRS. TEMPORARY EMERGENCY SHORING IS RECOMMENDED IF FACADE MOVEMENT IS OCCURRING AND/OR IF UNSTABLE CONDITIONS EXIST.

EXISTING CONDITIONS AND MODIFICATION NOTES:

- WEATHER BARRIER AND FLASHING SYSTEM: THE EXISTING WALLS ARE LIKELY CONSTRUCTED WITH INTERMITTENT WEATHER BARRIER AND DISCONTINUITIES ARE LIKELY PRESENT. WHERE NEW WEATHER BARRIER IS INSTALLED OR DISCONTINUITY IS EXPOSED/IDENTIFIED, IF WEATHER BARRIER CANNOT BE SHINGLE LAPPED WITH THE ROOF MEMBRANE OR EXISTING FLASHINGS, CONTRACTOR TO EXTEND THE WEATHER BARRIER OR INSTALL A SEALED TERMINATION BAR TO SEAL THE TOP EDGE OF THE WEATHER BARRIER. ALL WEATHER BARRIER AND FLASHINGS TO BE INSTALLED IN A SHINGLE LIKE MANNER, FREE OF VOIDS AND CAVITIES WHERE MOISTURE CAN ACCUMULATE, AND INSTALLED WITH FLASHINGS THAT DIRECT WATER OUTWARD AND AWAY FROM THE STRUCTURE.
- EXTERIOR SHEATHING: THE EXISTING WALLS ARE LIKELY CONSTRUCTED WITH VARYING TYPES OF EXTERIOR SHEATHING. WHERE SHEATHING IS REPLACED, CONTRACTOR TO INSTALL SHEATHING OF SIMILAR THICKNESS.
- INSULATION: THE EXISTING WALLS ARE LIKELY CONSTRUCTED WITH 2X4 STUD FRAMING. WHERE INSULATION IS REPLACED, IT IS LIKELY NOT FEASIBLE TO ACHIEVE THE CURRENT CODE REQUIREMENTS FOR INSULATION (R-VALUE) WITHIN EXTERIOR PERIMETER WALLS. CONTRACTOR TO FILL VOID COMPLETELY WITH BATT INSULATION OR AS REQUIRED BY THE LOCAL CODE OFFICIAL/INSPECTOR.
- VAPOR BARRIER: THE EXISTING WALLS ARE LIKELY CONSTRUCTED WITHOUT A VAPOR BARRIER. INSTALLATION OF A VAPOR BARRIER HAS NOT BEEN INCLUDED WITHIN THIS SCOPE AND IS LIKELY NOT FEASIBLE WITHOUT SUBSTANTIAL INTERIOR DRYWALL DEMOLITION. THE EXISTING MECHANICAL PERFORMANCE, FRESH AIR DELIVERY METHOD, AVAILABLE BATH EXHAUST SYSTEMS, AND THE POTENTIAL FOR ELEVATED HUMIDITY (INTERIOR DEW POINT) IS NOT KNOWN. THE OWNER HAS BEEN NOTIFIED OF THIS CONDITION AND THE POTENTIAL FOR VAPOR BYPASS THAT CAN RESULT IN CONDENSATION ON WINDOWS, DOORS, AND WITHIN THE BUILDING ENVELOPE.

- MECHANICAL SYSTEMS: THE INSPECTION, TESTING, DESIGN, AND MODIFICATION OF EXISTING MECHANICAL, VENTILATION, AND EXHAUST EQUIPMENT HAS BEEN EXCLUDED FROM THE SERVICES PROVIDED BY ENCOMPASS.
- ELECTRICAL SYSTEMS: THE INSPECTION, TESTING, DESIGN, AND MODIFICATION OF EXISTING ELECTRICAL SYSTEMS AND SERVICES HAS BEEN EXCLUDED FROM THE SERVICES PROVIDED BY ENCOMPASS.

GENERAL REPAIR WORK DESCRIPTIONS:

NOTE: SEE SUMMARY OF WORK AND DETAILS FOR ADDITIONAL INFORMATION AND REPAIR REQUIREMENTS.

MASONRY RECONSTRUCTION (1801 ELLIOT BUILDING - NORTH)

COMPLETED 2021

- LOCALIZED MASONRY REPAIRS
- 2A LOCALIZED MASONRY REPOINTING: REPOINT (TUCKPOINT) DETERIORATED MASONRY MORTAR JOINTS.
- 2B LOCALIZED BRICK REPLACEMENT: REMOVE AND REPLACE INDIVIDUAL CRACKED AND DAMAGED BRICK UNITS.
- MOBILIZATION/DEMOBILIZATION/GENERAL CONDITIONS: PROVIDE ALL TOOLS, NOTES 2C - LOCALIZED STONE REPAIRS: REMOVE AND REPLACE OR REPAIR STONE EQUIPMENT, FACILITIES, SAFETY MEASURES, AND PERMITS TO PERFORM THE BANDS WITHIN BRICK MASONRY. REPAIRS IN ACCORDANCE WITH CURRENT BUILDING CODE, CITY REQUIREMENTS, AND COMMON INDUSTRY STANDARDS.
- CAP METAL REPAIRS
- 3A REMOVE AND REINSTALL CAP METAL: REMOVE AND REINSTALL CAP METAL AT PARAPETS AND ROOF CURBS AS REQUIRED TO PERFORM WORK.
- 3B REMOVE AND REPLACE CAP METAL: REMOVE AND REPLACE CAP METAL AT AREA OF FACADE RECONSTRUCTION AS REQUIRED TO PERFORM WORK.
- STUCCO ELEVATION RECONSTRUCTION (EAST ELEVATIONS)
- CONTRACTOR TO FIELD MEASURE ALL EXISTING WINDOWS PRIOR TO PURCHASING TO ALLOW FOR PROPER INSTALLATION OF WINDOWS WITHOUT 4A - DEMOLITION (EAST ELEVATIONS): REMOVE AND DISPOSE ALL STUCCO. BRICK REMOVAL. THIS WILL REQUIRE INTERIOR ACCESS AND PARTIAL WEATHER BARRIER, EXTERIOR SHEATHING, AND INSULATION TO EXPOSE DRYWALL DEMOLITION FOR FIELD VERIFICATION OF ROUGH OPENING SIZE. WALL FRAMING. CONTRACTOR TO CONFIRM BRICK OPENING DIMENSIONS PRIOR TO ORDERING TO ALLOW FOR FLASHING, TRIM, AND MAINTAINABLE SEALANT JOINT INSTALLATION. SEE DETAILS FOR ADDITIONAL REQUIREMENTS.
- 4B BARRICADES/ENCLOSURES/SHORING (EAST ELEVATIONS): PROVIDE TEMPORARY BARRICADES, ENCLOSURES, AND SHORING FOR WALL RECONSTRUCTION TO STABILIZE AND TEMPORARY SHORE THE STRUCTURE DURING STRUCTURAL REPAIRS, PROVIDE DUST CONTAINMENT, AND TO PROVIDE FALL PROTECTION AND SITE SAFETY/SECURITY FOR RESIDENTS TO OCCUPY THEIR HOMES DURING THE REPAIRS TO THE EAST ELEVATION WALLS.
- 4C WALL RECONSTRUCTION (EAST ELEVATIONS): RECONSTRUCT WALL FRAMING BY REINFORCING AND/OR REPLACING DAMAGED FRAMING MEMBERS, REINSULATING THE WALL CAVITY, AND INSTALLING NEW EXTERIOR SHEATHING.
- 4D INTERIOR DRYWALL REPAIRS (EAST ELEVATIONS): REPAIR ALL INTERIOR DRYWALL AT WALL RECONSTRUCTION LOCATIONS INCLUDING DRYWALL REPLACEMENT, FASTENERS THROUGH EXISTING DRYWALL, CRACKS, AND NAIL POPS.
- 4E SIDING AND TRIM INSTALLATION (EAST ELEVATIONS): INSTALL NEW WEATHER BARRIER AND FLASHING SYSTEM. INSTALL NEW SIDING AND TRIM IN ACCORDANCE WITH MANUFACTURER'S RECOMMENDATIONS. SEE DETAILS FOR ADDITIONAL INFORMATION.

LOCALIZED FRAMING REPAIRS

- 5A REMOVE AND REPLACE DAMAGED SHEATHING: REMOVE AND REPLACE LOCALIZED DAMAGED EXTERIOR SHEATHING. NEW SHEATHING TO MATCH EXISTING THICKNESS.
- 5B REMOVE AND REPLACE DAMAGED BATT INSULATION: REMOVE AND REPLACE LOCALIZED BATT INSULATION THAT HAS BEEN EXPOSED TO MOISTURE.
- 5C REMOVE AND REPLACE DAMAGED STUD FRAMING: REMOVE AND REPLACE (OR REINFORCE) LOCALIZED DAMAGED WALL FRAMING MEMBERS, INCLUDING VERTICAL STUDS, PLATES, AND ROUGH OPENING FRAMING.
- 5D REMOVE AND REPLACE DAMAGED HEADERS: REMOVE AND REPLACE (OR

BUILDING NORTH & EAST ELEVATIONS BUILDING STRUCTURAL REPAIRS

DETAILS DETAILS

4.2 STRUCTURAL REPAIR DETAILS

- REINFORCE) LOCALIZED DAMAGED WINDOW AND DOOR HEADERS. PROVIDE TEMPORARY SHORING AS NEEDED.
- 5E REPAIR FLOOR RIM: REMOVE AND REPLACE LOCALIZED DAMAGED FLOOR RIM FRAMING. THIS WORK ITEM DOES NOT INCLUDE JOIST REPAIRS. CONTRACTOR TO NOTIFY ENGINEER IF DAMAGED FLOOR JOISTS ARE DISCOVERED.
- 5F REMOVE AND REPLACE DAMAGED DRYWALL: REPAIR DAMAGED INTERIOR DRYWALL. REPAIR TO GENERALLY CONSIST OF LOCALIZED REPLACEMENT, MUDDING, TAPING, SANDING, AND PRIMING (AT REPAIRS) TO A PAINT-READY CONDITION.
- WINDOW REPLACEMENT: REMOVE AND REPLACE ALL WINDOWS, EXCLUDING STOREFRONT ASSEMBLIES AT FRONT ENTRANCES.
- MISCELLANEOUS LABOR: PROVIDE A MISCELLANEOUS LABOR ALLOWANCE AND RATE FOR REPAIRS THAT ARE NOT REPRESENTED WITHIN A SPECIFIC WORK ITEM, BUT CAN BE PERFORMED ON A TIME AND MATERIAL BASIS.
- MOLD REMEDIATION: PERFORM MOLD REMEDIATION AS DIRECTED BY THE INDEPENDENT THIRD-PARTY TESTING AGENT.
- RIGGING/STAGING: PROVIDE ALL RIGGING AND STAGING REQUIRED FOR WORKER ACCESS TO PERFORM THE WORK AND TO ALLOW FOR ADEQUATE INSPECTION OF INSTALLATIONS.

GENERAL WINDOW REPLACEMENT NOTES:

- REMOVE AND REPLACE ALL EXISTING WINDOWS (INCLUDING STORM WINDOW PORTION OF FRAME) WITH MARVIN ESSENTIAL FIBERGLASS WINDOWS (WITH SCREENS). CONTRACTOR TO SUBMIT SHOP DRAWINGS THAT IDENTIFY PRODUCT, WINDOW PERFORMANCE CRITERIA, OPERABLE TYPE, AND HARDWARE TO OWNER FOR APPROVAL PRIOR TO PROCEEDING WITH REPLACEMENT.
- 3. INSTALLATION OF NEW WINDOWS TO INCLUDE ROUGH OPENING FLASHINGS, CLOSED CELL SPRAY FOAM ON ALL SIDES (AND WITHIN MULLIONS IF ASSEMBLED IN FIELD), EXTENSION JAMBS, INTERIOR SILL MATERIAL, SEALANTS, TRIM, AND APPLICABLE COATINGS.
- 4. ALL WEATHER BARRIER AND ROUGH OPENING FLASHINGS TO BE SHINGLE-LAPPED. SEE DETAIL 2 / 4.0 FOR TYPICAL WEATHER BARRIER AND FLASHING INSTALLATIONS AT WINDOW REPLACEMENT LOCATIONS. SEE SECTION DETAILS FOR ADDITIONAL INFORMATION. ALL SILL FLASHING TO BE INSTALLED WITH AN UPTURNED LEG TO PREVENT INCIDENTAL WATER DRAINING TOWARDS THE INTERIORS. THIS UPTURNED LEG TO BE BETWEEN THE WINDOW FRAME AND THE EXTENSION JAMB (ALONG THE SILL). THE SILL FLASHING SHALL BE A NON-CONDUCTIVE MATERIAL, SUCH AS TYVEK FLEX WRAP.
- 5. CONTRACTOR TO INSTALL FLANGED WINDOW FRAMES WHERE EXTERIOR

FAÇADE MATERIAL IS REMOVED AND/OR AS BRICK OPENINGS ALLOW. IF BLOCK-FRAMED (NO NAILING FLANGE) WINDOWS ARE REQUIRED. CONTRACTOR TO INSTALL SELF-ADHERED FLASHING TAPE AND/OR 90-DEGREE BENT METAL TO BACK SEAL TO BRICK AND CREATE AN AIR BARRIER TO PREVENT AIR FROM MIGRATING FROM THE BRICK CAVITY INTO THE ROUGH OPENING.

- IT IS RECOMMENDED THAT ONE WINDOW INSTALLATION MOCK-UP BE PERFORMED PER FAÇADE MATERIAL TYPE AND THAT EACH MOCK-UP BE TESTED PER AAMA STANDARDS PRIOR TO PROCEEDING WITH FURTHER REPLACEMENT IN THAT FACADE MATERIAL. AAMA TEST TO BE PERFORMED TO DETERMINE ANTICIPATED PERFORMANCE OF INSTALLATION WITHIN VARYING SITE-SPECIFIC CONDITIONS/INSTALLATIONS AND IF ADDITIONAL FLASHINGS AND SEALANTS ARE REQUIRED.
- IT IS SUSPECTED THAT THERE ARE DISCONTINUITIES WITHIN THE EXISTING WEATHER BARRIER AND FLASHING SYSTEM BEHIND BRICK. THEREFORE, THE FAÇADE AND WINDOWS/DOORS THAT PENETRATE THROUGH THE FAÇADE IS REQUIRED TO PERFORM AS A BARRIER SYSTEM TO RESIST WATER INTRUSION. THEREFORE, THE PERFORMANCE OF THE FAÇADE AND WINDOWS/DOORS WILL BE DEPENDENT UPON REGULAR MAINTENANCE OF THE FAÇADE. IN GENERAL, A MASONRY BARRIER SYSTEM REQUIRES REGULAR MAINTENANCE OF BRICK, MORTAR, SEALANTS, AND PRODUCTS THAT PENETRATE THE MASONRY. IN SOME INSTANCES, A CLEAR PENETRATING SEALER (WATER REPELLANT) MAY BE REQUIRED. THESE MAINTENANCE REQUIREMENT ARE THE RESPONSIBILITY OF THE OWNER.


HARMFUL AND HAZARDOUS MATERIAL

- ENCOMPASS DOES NOT PERFORM INSPECTIONS OR TESTING OF EXISTING HARMFUL AND/OR HAZARDOUS SUBSTANCES SUCH AS (NOT LIMITED TO) LEAD, MOLD, AND ASBESTOS. THESE SERVICES ARE NOT PERFORMED BY ENCOMPASS. IT IS RECOMMENDED THAT THE OWNER CONSULT WITH A TESTING AGENT FOR THESE SERVICES PRIOR TO PROCEEDING WITH CONSTRUCTION.
- 2. IT IS RECOMMENDED THAT THE OWNER CONSULT AN INDEPENDENT THIRD-PARTY TESTING AGENT FOR HARMFUL AND/OR HAZARDOUS MATERIALS TO IDENTIFY POTENTIALLY HARMFUL SUBSTANCES AND PROVIDE DIRECTION TO THE CONTRACTOR ON PROPER ABATEMENT PROCEDURES. THESE SERVICES ARE NOT PERFORMED BY ENCOMPASS.

PHASE II PERMIT SET

HASE II	Encom
	engineering forer
	5435 Feltl Minnetonka, M Tel: (952) 85
	www.encompa
	CONSULTANTS:
	CERTIFICATION:
own	I hereby certify that th prepared by me or un supervision and that I Licensed Professiona the laws of the State of Signature Name Date Registration Number
Health Alliance Apartments Catholic Charities Opportunity Center Oppo	Project Number: 22-7
33 CM Inner City Church SSA Twin Cities Card Center	Date: 02/18/
E 19th St E 19th St	Drawn:MKM Checked:MKM Scale:AS NO
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	PROJECT:
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	REPAIR PROJECT CITYVIEW CO-OP
	MINNEAPOLIS, MI
	SHEET TITLE: TITLE SHEET
	SHEET NUMBER:
2/18/2022	

Encompass
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CONSULTANTS:
CERTIFICATION: I hereby certify that this drawing was prepared by me or under my direct supervision and that I am a duly Licensed Professional Engineer under the laws of the State of Minnesota. Signature
Project Number: 22-7311-003 Date: 02/18/2022 Drawn: MDT Checked: MKM Scale: AS NOTED
REVISIONS:
PROJECT:
2022 EXTERIOR FACADE REPAIR PROJECT - PHASE II CITYVIEW CO-OP MINNEAPOLIS, MN
SHEET TITLE: TITLE SHEET

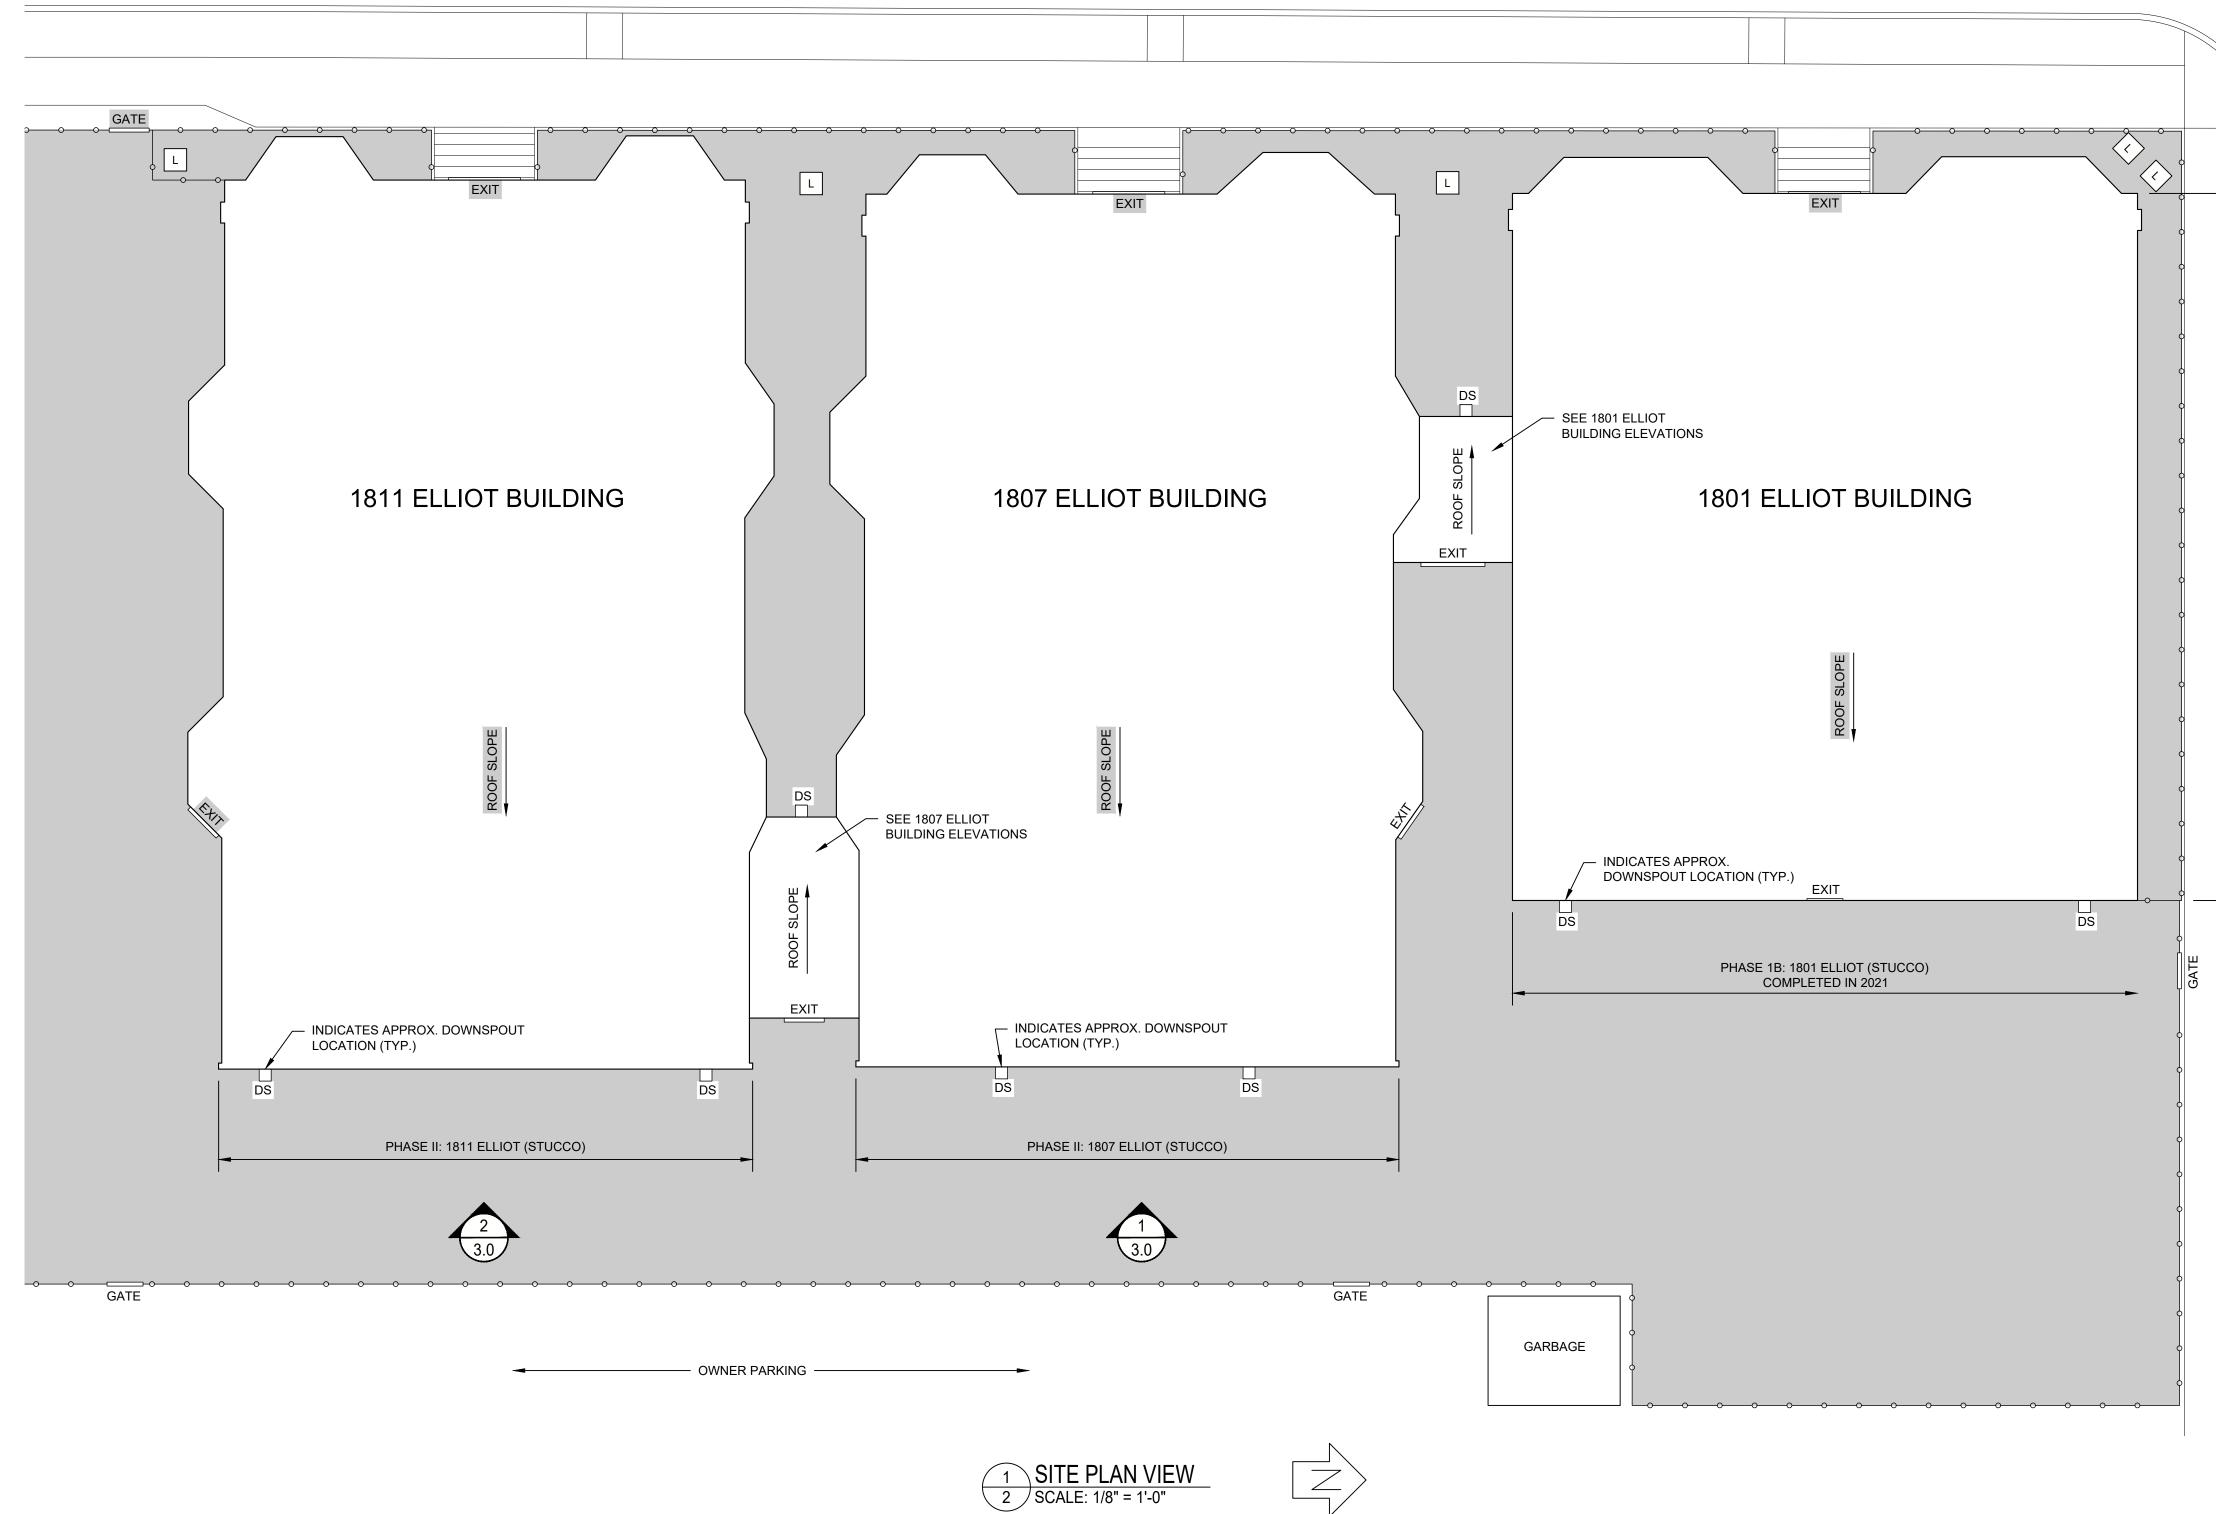




G	ENERAL SITE PLAN PHASING NOTES	Encompass
1.	THE REPAIR PHASES IDENTIFIED WITHIN THESE DRAWINGS ARE BASED ON REPAIR PRIORITIZATIONS WHERE ACTIVE WATER INTRUSION IS KNOWN AND REFERENCED WITHIN THE ENCOMPASS REPORT DATED JUNE 25, 2020.	engineering consultants forensic analysis
2.	PHASE II IS GENERALIZED AS THE EAST ELEVATIONS OF THE 1807 & 1811 BUILDINGS WHERE STUCCO WALL RECONSTRUCTION IS REQUIRED.	5435 Feltl Road
3.	A PRIVACY AND SECURITY FENCE IS PRESENT AT THE PERIMETER OF THE SITE. THE CONTRACTOR IS TO COORDINATE FENCE DECONSTRUCTION AND RECONSTRUCTION AS REQUIRED TO MAINTAIN SITE SECURITY AND SAFETY.	Minnetonka, MN 55343 Tel: (952) 854-4511
4.	AN ALLEY IS PRESENT ALONG THE EAST SIDE OF THE PROPERTY. THIS ALLEY SERVICES MULTIPLE BUILDINGS/HOMES AND IS NOT TO BE BLOCKED. OWNER PARKING IS ALSO PRESENT ALONG THE EAST ELEVATION. CONTRACTOR IS TO COORDINATE WITH OWNER FOR WORKER PARKING, MATERIAL STORAGE, STAGING, AND SITE DELIVERIES.	www.encompassinc.com
5.	THESE PLANS ARE A VISUAL REPRESENTATION OF THE APPROXIMATE SITE LAYOUT AND FEATURES. THE SCALE REPRESENTED ON THESE DRAWINGS IS NOT TO BE SCALED FOR MATERIAL ORDERING OR INSTALLATION. THE CONTRACTOR IS RESPONSIBLE FOR ALL FIELD VERIFICATION OF DIMENSIONS AND EXISTING CONDITIONS.	
		CERTIFICATION: I hereby certify that this drawing was prepared by me or under my direct supervision and that I am a duly Licensed Professional Engineer under the laws of the State of Minnesota. Signature Name Date Registration Number
STREET		Project Number: 22-7311-003 Date: 02/18/2022 Drawn: MDT Checked: MKM Scale: AS NOTED
EAST 18TH		REVISIONS:
		PROJECT: 2022 EXTERIOR FACADE REPAIR PROJECT - PHASE II CITYVIEW CO-OP MINNEAPOLIS, MN
		SHEET TITLE: SITE PLAN VIEW
		SHEET NUMBER:

1801 ELLIOT - NO PLETED IN 2021

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1807 ELLIOT - EAST ELEVATION NOTES:

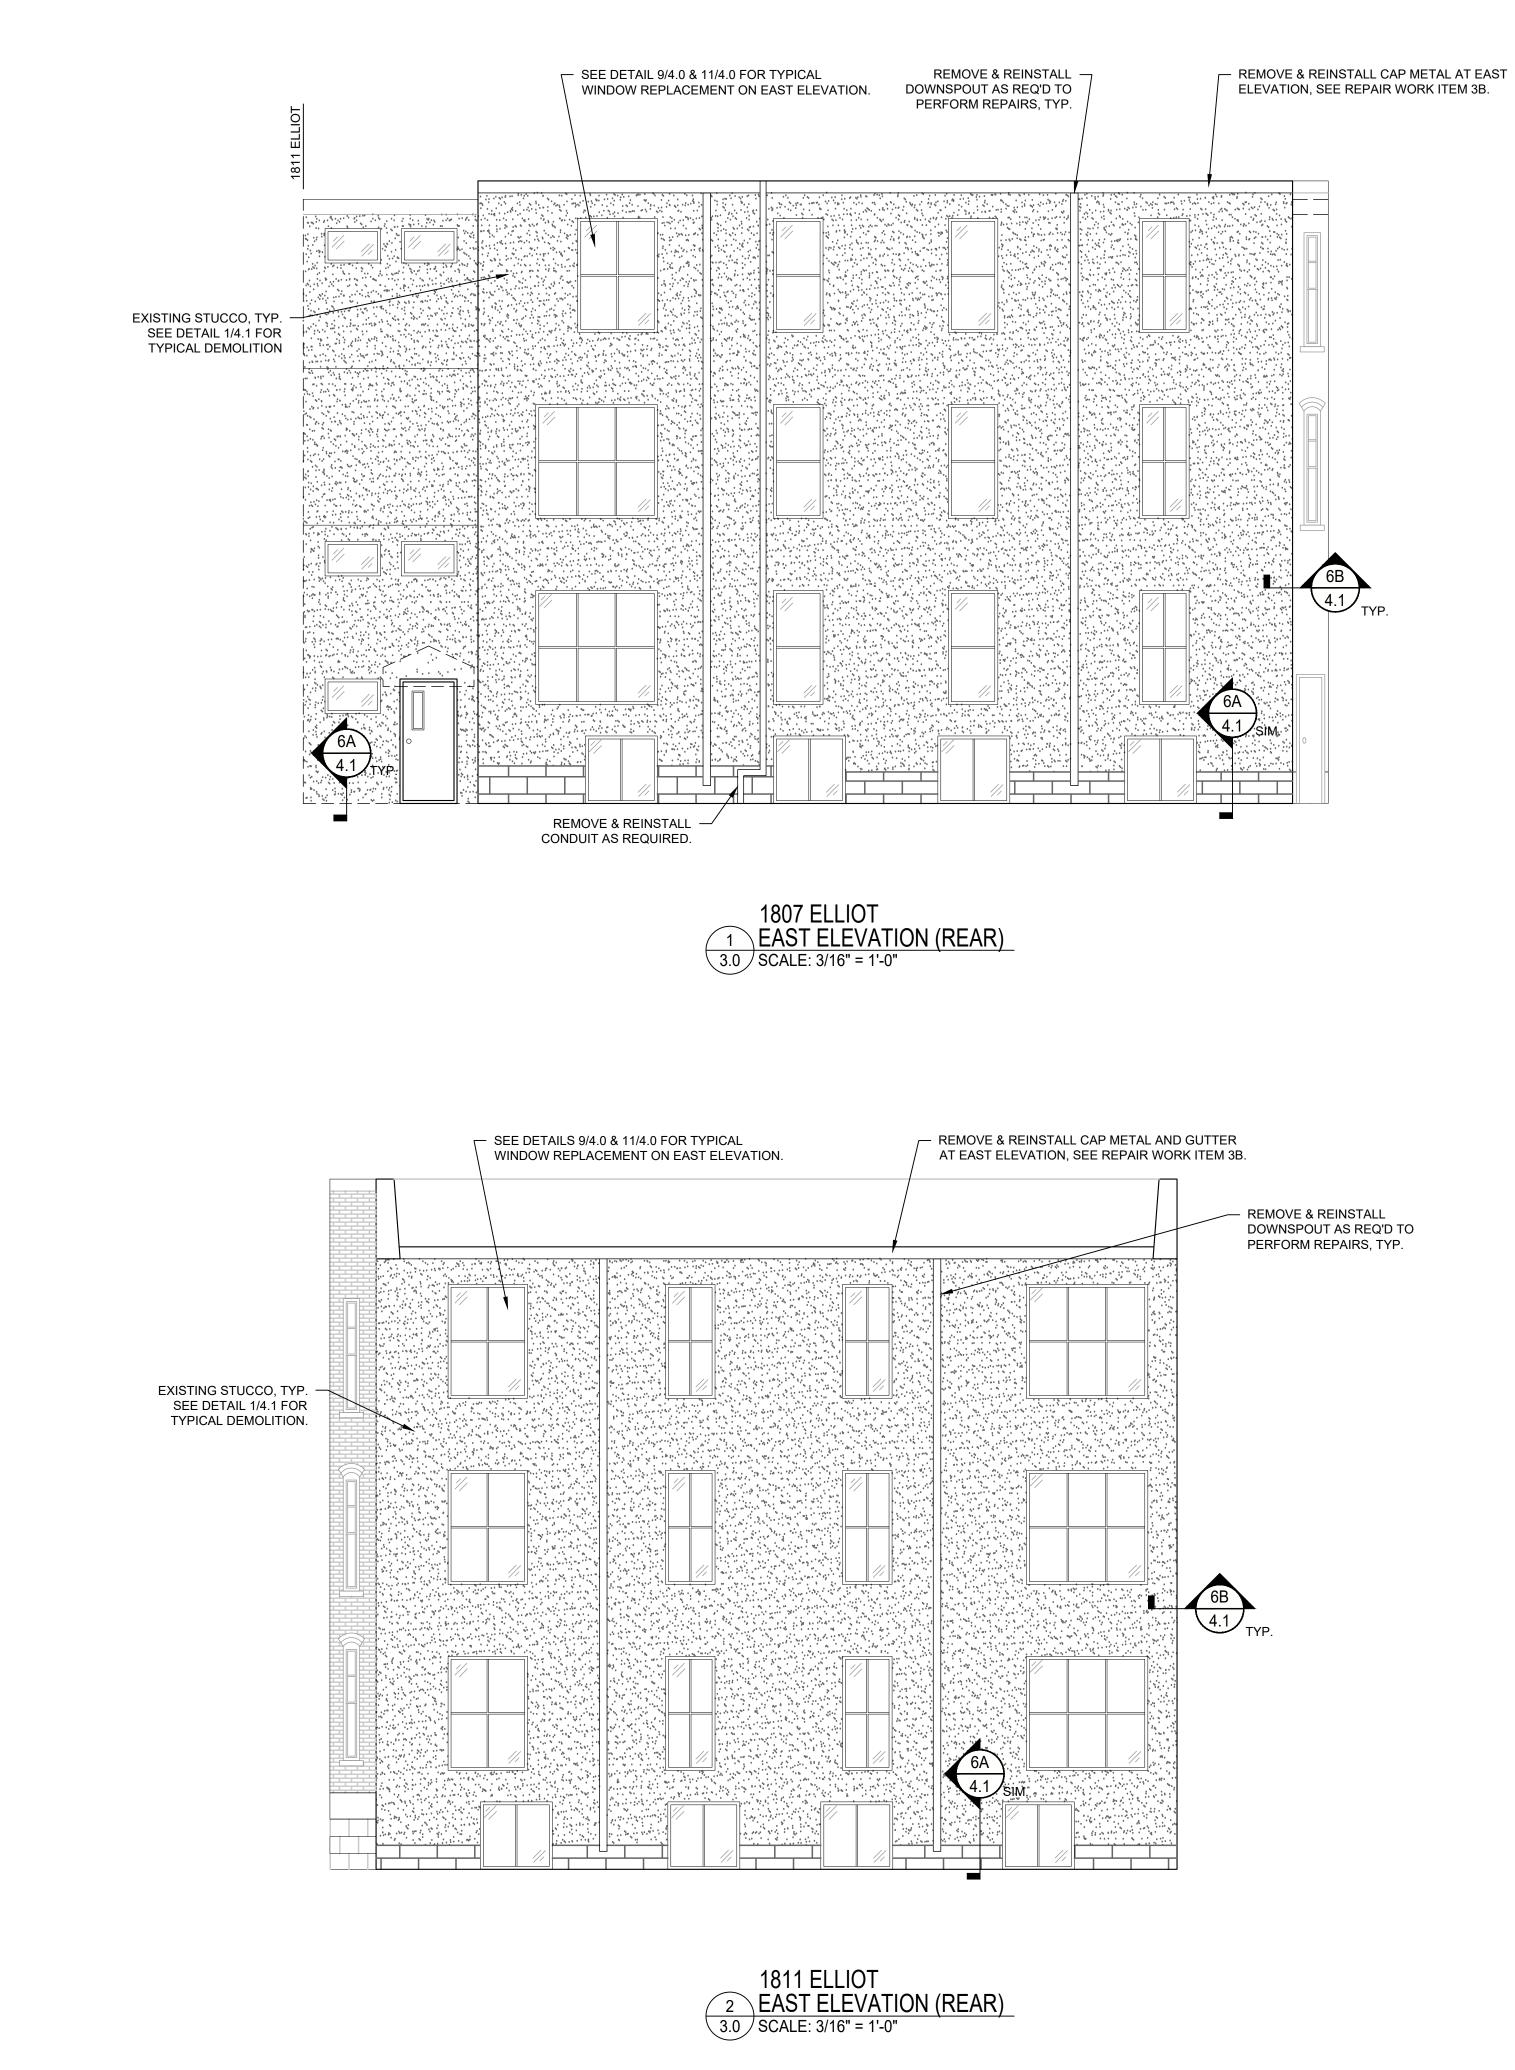- 1. REMOVE AND DISPOSE OF ALL STUCCO, EXTERIOR SHEATHING, AND BATT INSULATION TO EXPOSE WALL FRAMING. SEE REPAIR WORK ITEM 4A.
- 2. SUBSTANTIAL WALL FRAMING DAMAGES ARE ANTICIPATED. PROVIDE SHORING, TEMPORARY BRACING, AND OVERHEAD PROTECTION AS REQUIRED TO PERFORM REPAIRS. CONTRACTOR TO BE RESPONSIBLE FOR THE MEANS AND METHODS OF CONSTRUCTION. REFRENCE REPAIR WORK ITEM 4B FOR BARRICADES, ENCLOSURES, AND SHORING.
- 3. REMOVE AND REPLACE ALL WINDOWS. SEE DETAILS AND REPAIR WORK ITEM 6 FOR ADDITIONAL INFORMATION.
- 4. REPAIR WATER DAMAGED FRAMING AND RECONSTRUCT WALL. SEE REPAIR WORK ITEM 4C FOR TYPICAL REPAIRS TO FRAMING MEMBERS FOR RECONSTRUCTION OF WALL.
- 5. PERFORM MOLD REMEDIATION IN ACCORDANCE WITH THE DIRECTIONS PROVIDED BY THE INDEPENDENT THIRD-PARTY MOLD TESTING AGENT. SEE REPAIR WORK ITEM 8.


- 6. DEMOLITION AND REPAIRS TO LIKELY RESU DRYWALL NAIL POPS, CRACKS, AND NEW FA INSTALLED THROUGH EXISTING DRYWALL. DRYWALL AT INTERIOR OF HOMES FOLLOW AND TRIM INSTALLATION. SEE REPAIR WOF FOR INTERIOR DRYWALL REPAIRS.
- 7. REPLACE ALL STUCCO WITH FIBER-CEMENT LAP SIDING AND TRIM. INSTALL 6-INCH TRIM AROUND ALL WINDOWS, WALL PENETRATIONS, AND ALONG MATERIAL TRANSITIONS. SEE REPAIR WORK ITEM 4E AND REPAIR DETAILS FOR ADDITIONAL INFORMATION.
- 8. SEE ELEVATIONS, DETAILS, AND SUMMARY OF WORK FOR ADDITIONAL INFORMATION.

- 1811 ELLIOT EAST ELEVATION NOTES:
- 1. REMOVE AND DISPOSE OF ALL STUCCO, EXTERIOR SHEATHING, AND BATT INSULATION TO EXPOSE WALL FRAMING. SEE REPAIR WORK ITEM 4A.
- 2. SUBSTANTIAL WALL FRAMING DAMAGES ARE ANTICIPATED. PROVIDE SHORING, TEMPORARY BRACING, AND OVERHEAD PROTECTION AS REQUIRED TO PERFORM REPAIRS. CONTRACTOR TO BE RESPONSIBLE FOR THE MEANS AND METHODS OF CONSTRUCTION. REFERENCE REPAIR WORK ITEM 4B FOR BARRICADES, ENCLOSURES, AND SHORING.
- 3. REMOVE AND REPLACE ALL WINDOWS. SEE DETAILS AND REPAIR WORK ITEM 6 FOR ADDITIONAL INFORMATION.
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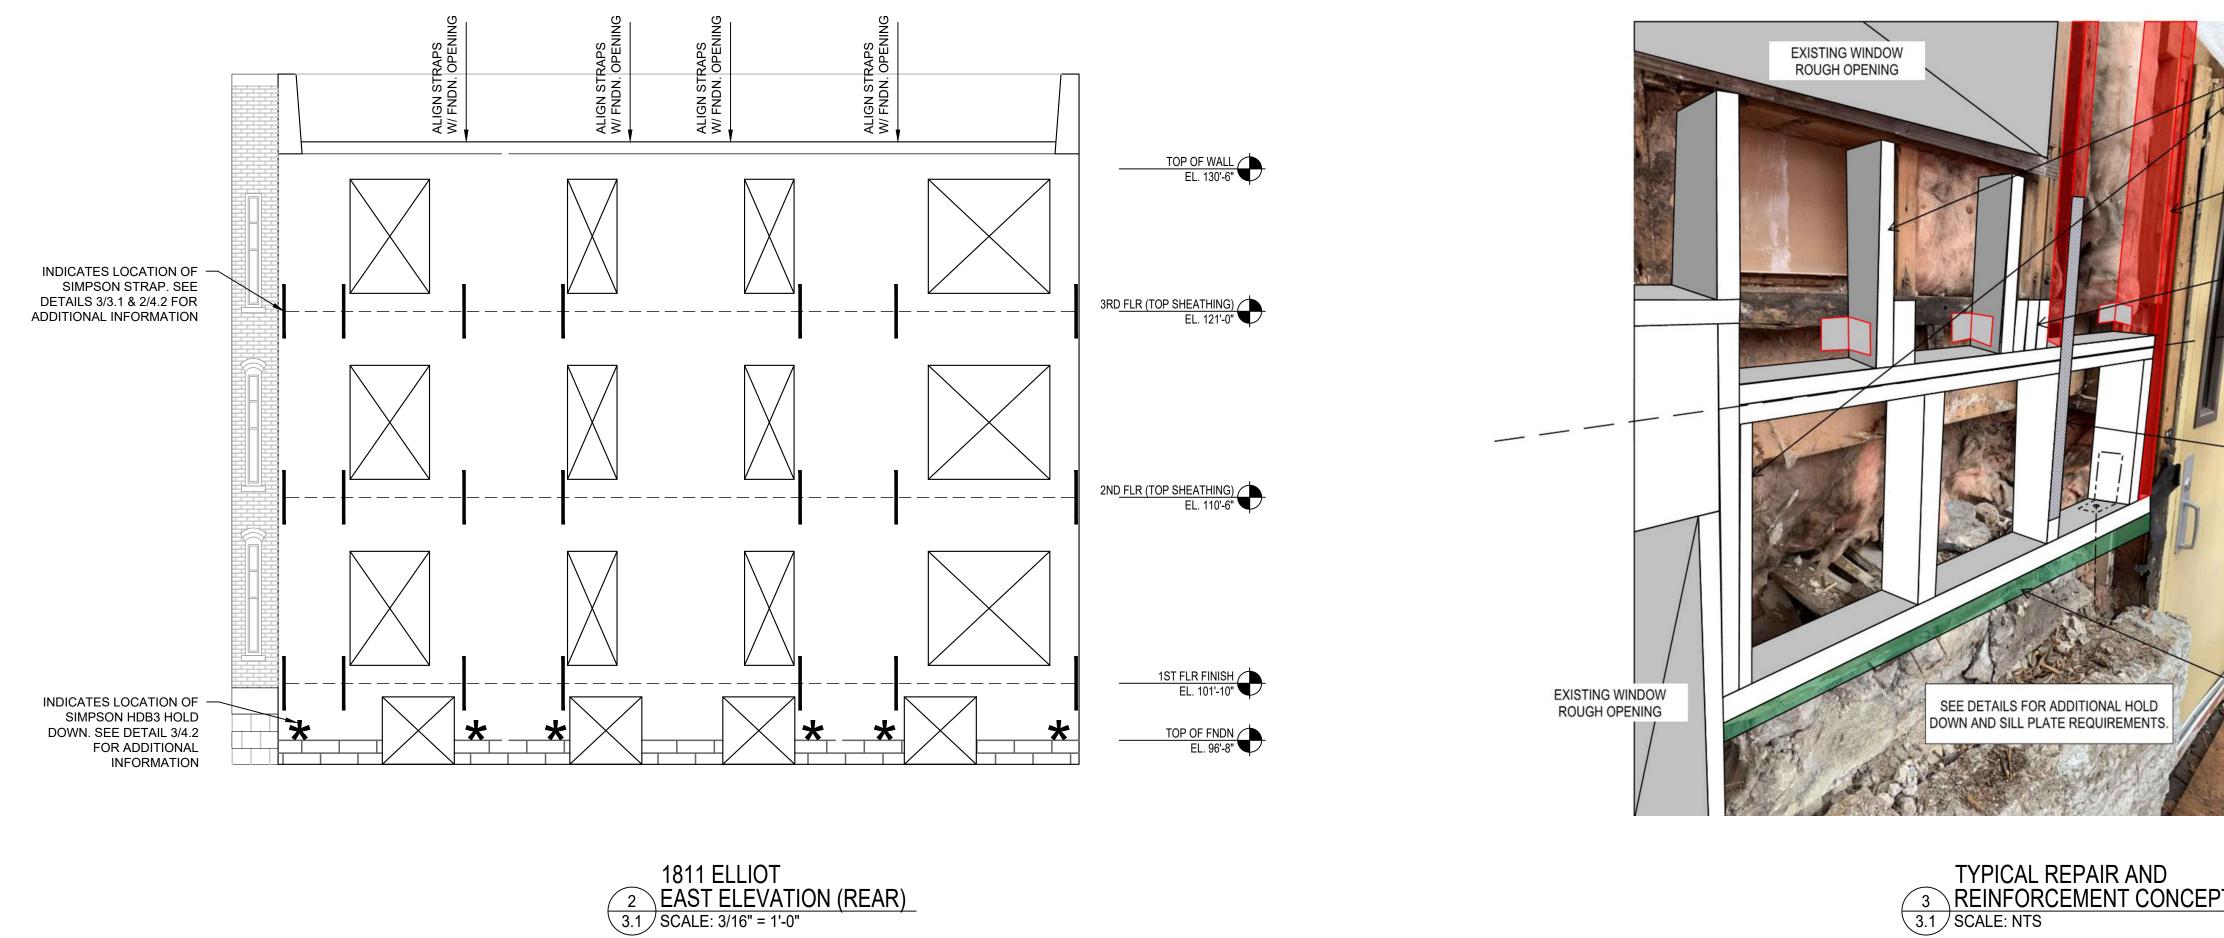
- 6. DEMOLITION AND REPAIRS TO LIKELY RESULT IN DRYWALL NAIL POPS, CRACKS, AND NEW FASTENERS INSTALLED THROUGH EXISTING DRYWALL. REPAIR DRYWALL AT INTERIOR OF HOMES FOLLOWING SIDING AND TRIM INSTALLATION. SEE REPAIR WORK ITEM 4D FOR INTERIOR DRYWALL REPAIRS.
- 7. REPLACE ALL STUCCO WITH FIBER-CEMENT LAP SIDING AND TRIM. INSTALL 6-INCH TRIM AROUND ALL WINDOWS, WALL PENETRATIONS, AND ALONG MATERIAL TRANSITIONS. SEE REPAIR WORK ITEM 4E AND REPAIR DETAILS FOR ADDITIONAL INFORMATION.
- 8. SEE ELEVATIONS, DETAILS, AND SUMMARY OF WORK FOR ADDITIONAL INFORMATION.

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CONSULTANTS:
CERTIFICATION: I hereby certify that this drawing was prepared by me or under my direct supervision and that I am a duly Licensed Professional Engineer under the laws of the State of Minnesota. Signature Name Date Registration Number
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REVISIONS:
PROJECT: 2022 EXTERIOR FACADE REPAIR PROJECT - PHASE II CITYVIEW CO-OP MINNEAPOLIS, MN
SHEET TITLE: 1807 & 1811 BUILDINGS EAST ELEVATIONS
SHEET NUMBER:



1807 ELLIOT 1 EAST ELEVATION (REAR) 3.1 SCALE: 3/16" = 1'-0"

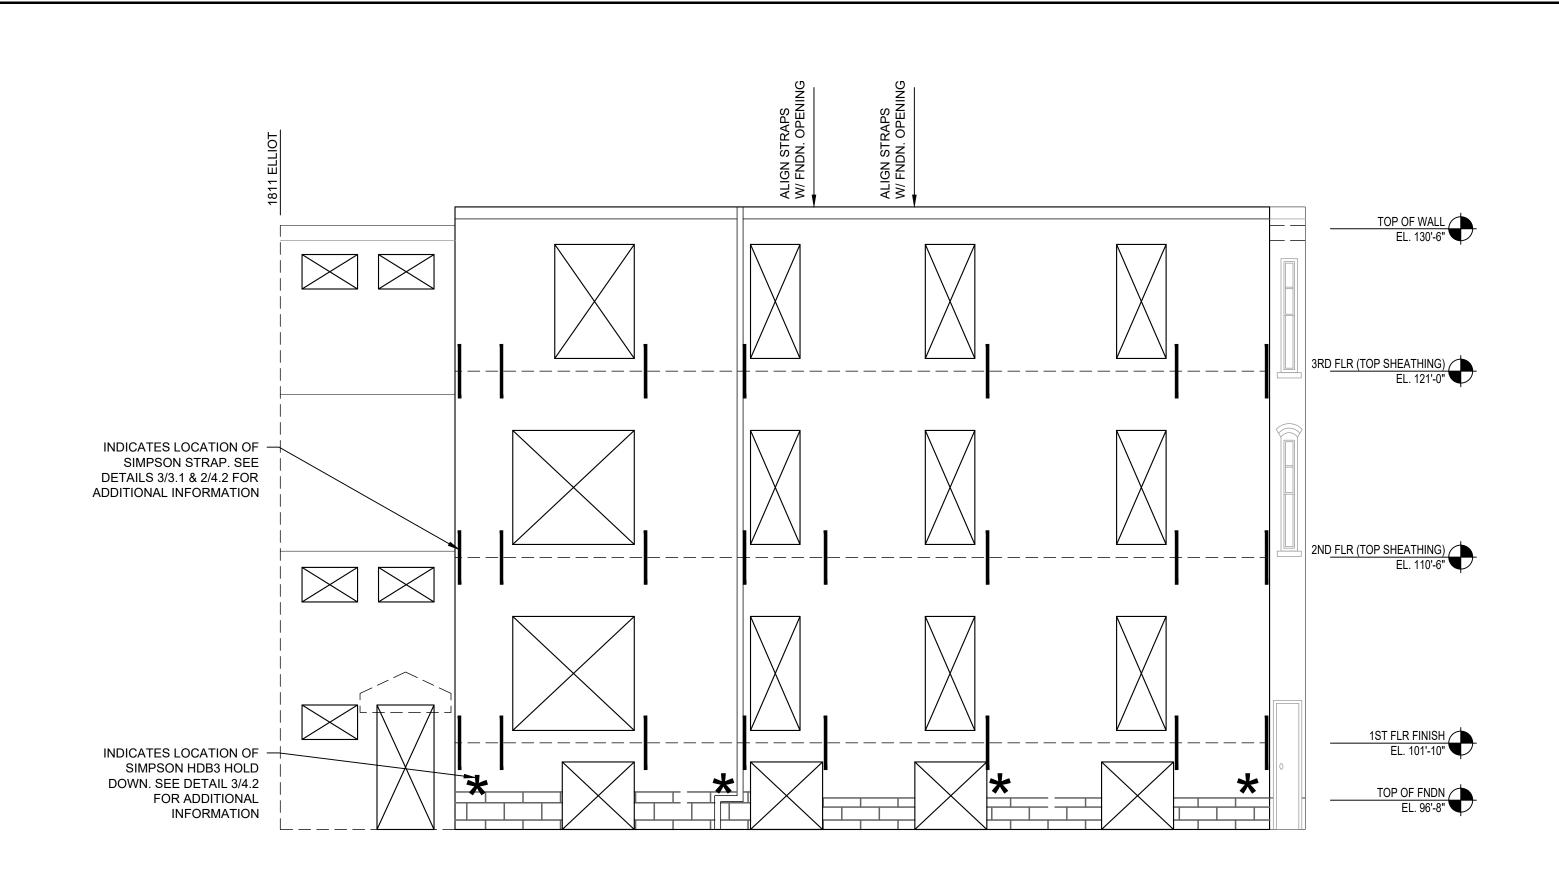



SUBSTANTIAL REPAIR FRAMING NOTES:


- 1. ORIGINAL WALL CONSTRUCTION CONSISTS OF 2x4 ROUGH SAWN LUMBER WITH 5/8" INTERIOR DRYWALL AND 3/4" TONGUE AND GROOVE PLANKS.
- 2. EXISTING 3/4" TONGUE AND GROOVE PLANKS WERE REMOVED & DISPOSED OF DUE TO EXTERIOR WATER INTRUSION DAMAGES.

- 3. REPAIR TO CONSIST OF CUTTING & REMOVING PORTIONS OF WATER DAMAGED STUD FARMING AND REINFORCING EXISTING STUDS WITH 2x4 SPF MSR-2400/2.0E FULL HEIGHT STUDS. AT LOCATIONS WHERE FRAMING IS LESS THAN 6'-0" IN LENGTH, CONTRACTOR MAY SUBSTITUTE REINFORCEMENT WITH FULL HEIGHT 2x4 SPF #2 OR BETTER. REINFORCEMENT TO BE SISTERED TO SIDE OF EXISTING STUDS PER NDS RECOMMENDATIONS.
- 4. CONTRACTOR TO CUT EXISTING BALLOON FRAMING STUDS AT FLOOR LINES AND INSTALL A CONTINUOUS DOUBLE PLATE ALONG EACH FLOOR LINE.
- 5. CONTRACTOR TO ATTACH WALL FRAMING TO FLOOR DIAPHRAGM AT OR BELOW EXISTING FLOOR LINE WITH FRAMING CLIPS.
- 6. CONTRACTOR TO INSTALL STRAP AND HOLD DOWNS FOR LATERAL WIND LOAD DISTRIBUTION PER 1/4.2. STRAP AND HOLD DOWN LOCATIONS TO BE ALIGNED. CONTRACTOR TO INSTALL ADDITIONAL REINFORCEMENT FRAMING AND BLOCKING AS REQUIRED TO ALIGN STRAPS AND HOLD DOWNS.
- 7. ALL EXTERIOR SHEATHING ON THE EAST ELEVATION TO BE REPLACED WITH 7/16" APA RATED EXTERIOR SHEATHING, ORIENTED VERTICALLY WITH HORIZONTAL JOINTS BLOCKED. PLYWOOD WALL PANELS SHALL BE ORIENTED WITH FACE GRAIN PARALLEL TO SUPPORT STUD.
- 8. REMOVE & REPLACE DAMAGED BATT INSULATION WITH MINERAL WOOL. COMPRESSION FIT ALL INSULATION. CONTRACTOR MAY SUBSTITUTE BATT INSULATION FOR MINERAL WOOL IF ALL CAPS AND VOIDS ARE FILLED. LIKELY VOID LOCATIONS ARE AT REINFORCEMENT LOCATIONS BETWEEN INTERIOR SHEATHING AND REINFORCEMENT MEMBER. CONTRACTOR TO PROVIDE WRITTEN NOTIFICATION OF SUBSTITUTION TO OWNER AND SHALL BE RESPONSIBLE FOR THE INSPECTION OF ALL VOIDS PRIOR TO BATT INSULATION INSTALLATION.


		Encompass
		engineering consultants forensic analysis
	PERFORM VAPOR BARRIER REPAIRS WHERE CUTS, TEARS, AND VOIDS ARE PRESENT. IT IS RECOMMENDED THAT THE CONTRACTOR INSPECT ALL VAPOR BARRIER APPLICATIONS PRIOR INSULATING WALL.	5435 Feltl Road Minnetonka, MN 55343
	IF CONDITIONS ARE DISCOVERED THAT VARY FROM THOSE REPRESENTED HEREIN, CONTRACTOR TO NOTIFY ENGINEER PRIOR TO PROCEEDING.	Tel: (952) 854-4511
	SEE ELEVATION DRAWINGS, DETAILS, AND SUMMARY OF WORK FOR ADDITIONS. INFORMATION.	www.encompassinc.com
	REPAIRS TO BE IN ACCORDANCE WITH THE 2020 MINNESOTA CONSERVATION CODE FOR EXISTING BUILDINGS AS REFERENCED WITHIN THE 2020 MINNESOTA STATE BUILDING CODE. FOR EAST WALL, MAIN WIND FORCE RESISTING SYSTEM AND COMPONENTS AND CLADDING LOADS BASED ON A ASCE 7-16 AS REFERENCED WITHIN THE 2020 MINNESOTA STATE BUILDING CODE.	CONSULTANTS:
2.	THIS REPAIR IS SPECIFIC TO THE EAST ELEVATION OF EAST 1801 ELLIOT AVE, MINNEAPOLIS, MN .	
3.	ALL MACHINE STRESS RATED LUMBER TO BE SPF WITH Fb = 2400 psi, Fc = 1975 psi. AND E=2,000,000 psi.	
4.	ALL WOOD IN DIRECT CONTACT WITH CONCRETE, STONE, OR MASONRY TO BE PRESSURE TREATED.	
5.	ALL WOOD FASTENING TO BE IN ACCORDANCE WITH NDS RECOMMENDATIONS.	
		CERTIFICATION: I hereby certify that this drawing was prepared by me or under my direct supervision and that I am a duly Licensed Professional Engineer under the laws of the State of Minnesota. Signature Name Date Registration Number
	AT LOCATIONS WHERE STUD REPLACEMENT OR REINFORCEMENT	Project Number: 22-7311-003 Date: 02/18/2022 Drawn: MDT Checked: MKM Scale: AS NOTED
L	LENGTH IS LESS THAN 6'-0", INSTALL 2x4 SPF GRADE #2 OR SPF MSR-2400/2.0E.	REVISIONS:
ł	AT LOCATIONS OF FULL HEIGHT STUD REPLACEMENT OR REINFORCEMENT, INSTALL 2x4 MSR-2400/2.0E. INSTALL IN A MANNER THAT THE GRADING STAMP IS VISIBLE FOR INSPECTION.	
	BLOCK EXISTING STUDS TO REMAIN IN PLACE AS NEEDED WITH 2x4 SPF GRADE #2 OR MSR-2400/2.0E.	
$\left \right $		PROJECT:
	ALIGN STUDS AT STRAP LOCATIONS. STRAP TO BE VERTICALLY ALIGNED OVER DOUBLE PLATE. NOTE: EXTERIOR WALL ON EAST ELEVATION DOES NOT SUPPORT FLOOR TRUSSES. AT LOCATIONS WHERE	2022 EXTERIOR FACADE REPAIR PROJECT - PHASE II CITYVIEW CO-OP MINNEAPOLIS, MN
	MULTIPLE POSTS ARE SISTERED TOGETHER, CONTRACTOR TO COORDINATE WITH STRUCTURAL ENGINEER ADDITIONAL BLOCKING REQUIREMENTS PRIOR TO SHEATHING INSTALLATION. ANY WOOD FRAMING MEMBER IN DIRECT CONTACT WITH CONCRETE, STONE, OR MASONRY TO BE PRESSURE	SHEET TITLE: 1807 & 1811 BUILDINGS EAST ELEVATIONS
F	TREATED.	
CEF		SHEET NUMBER:

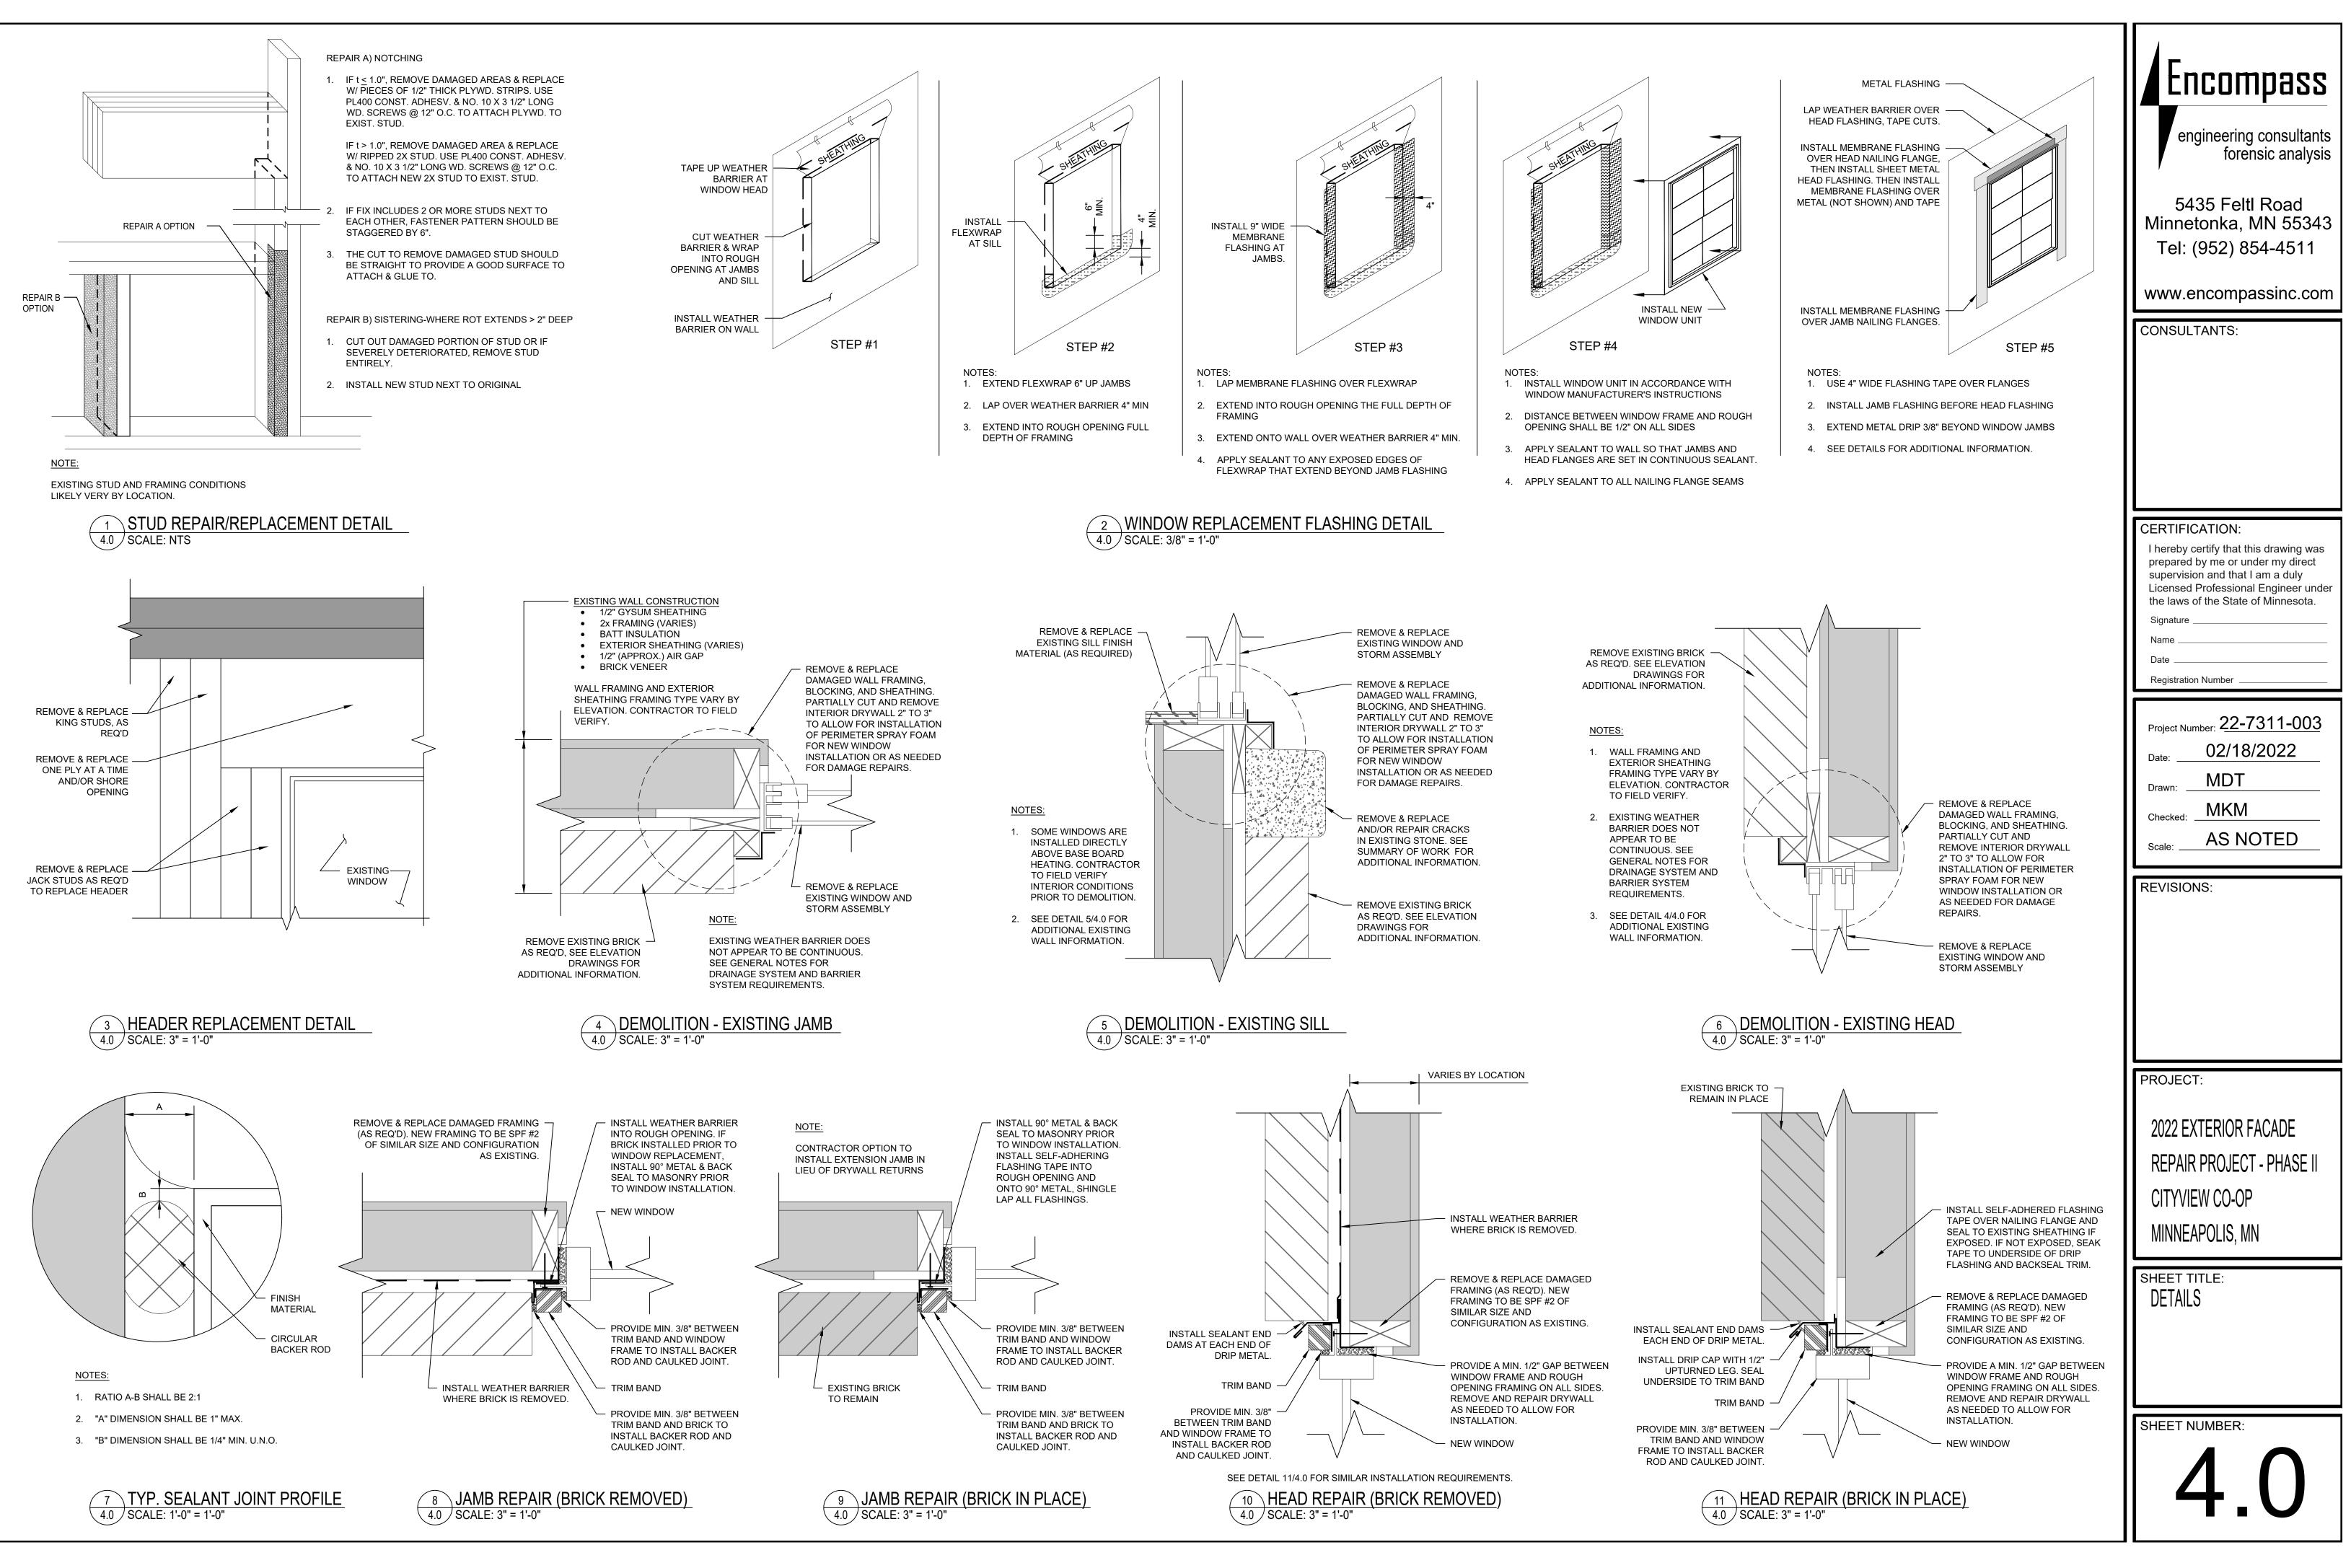

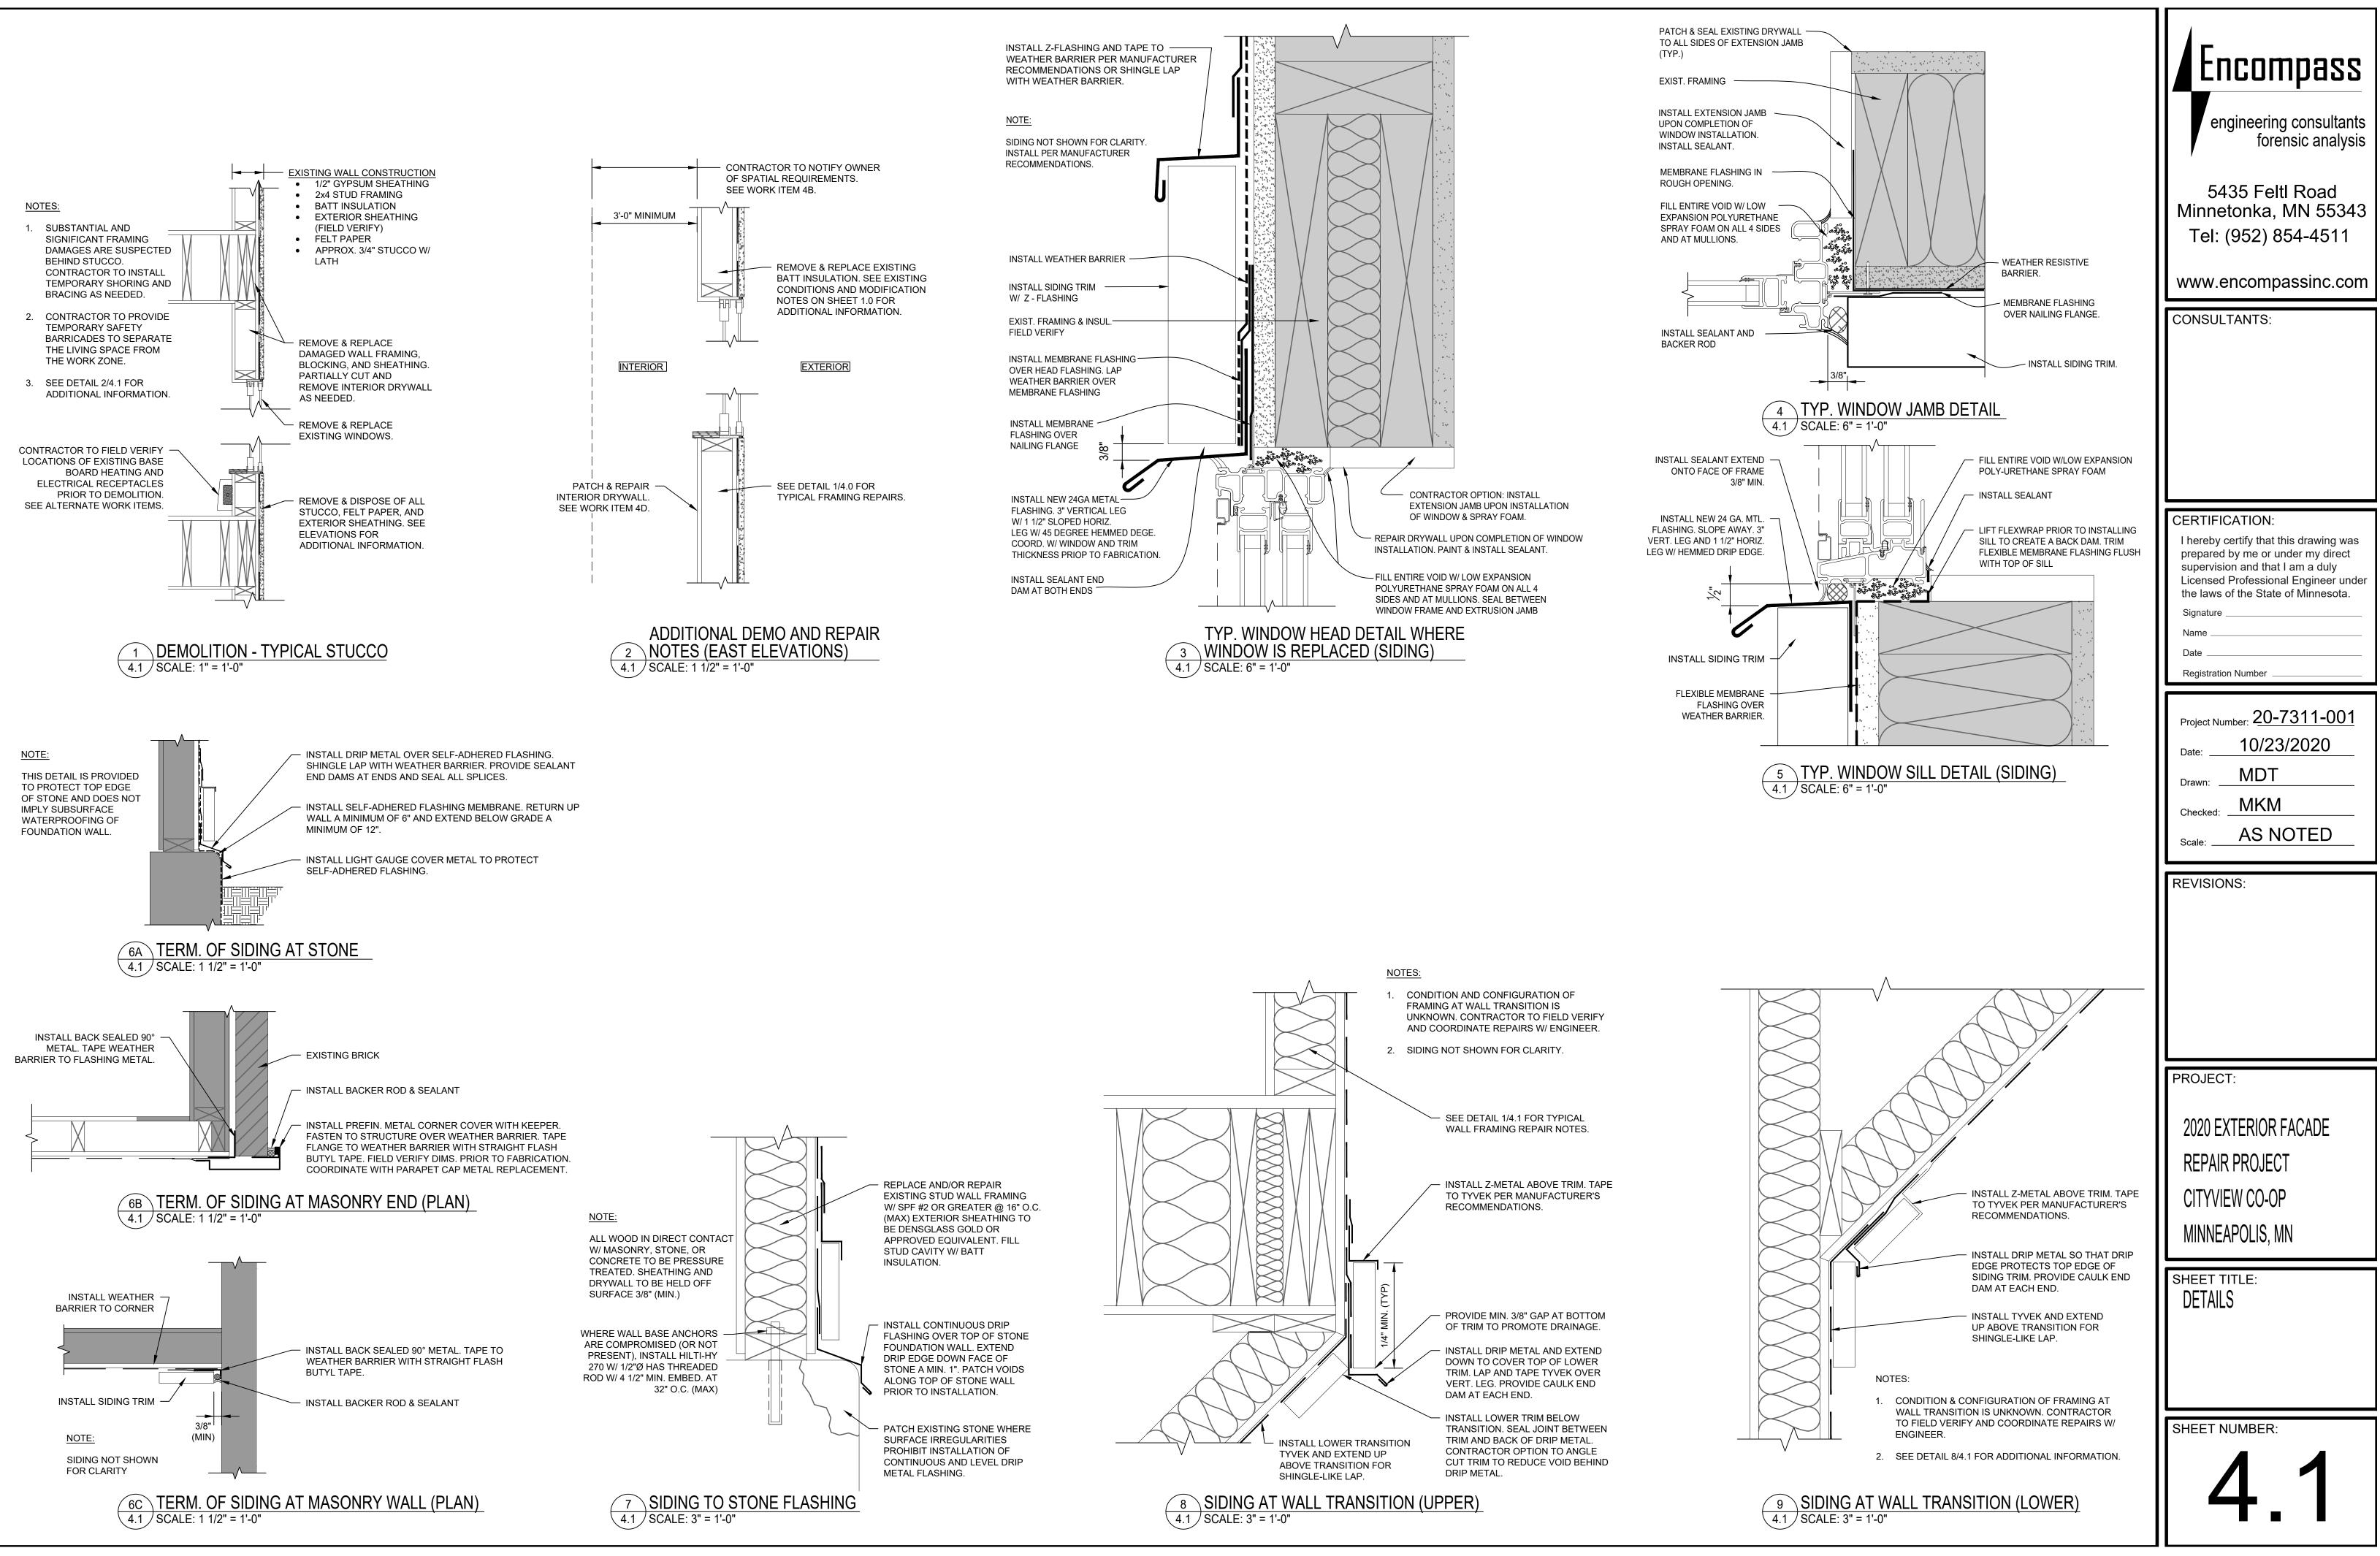

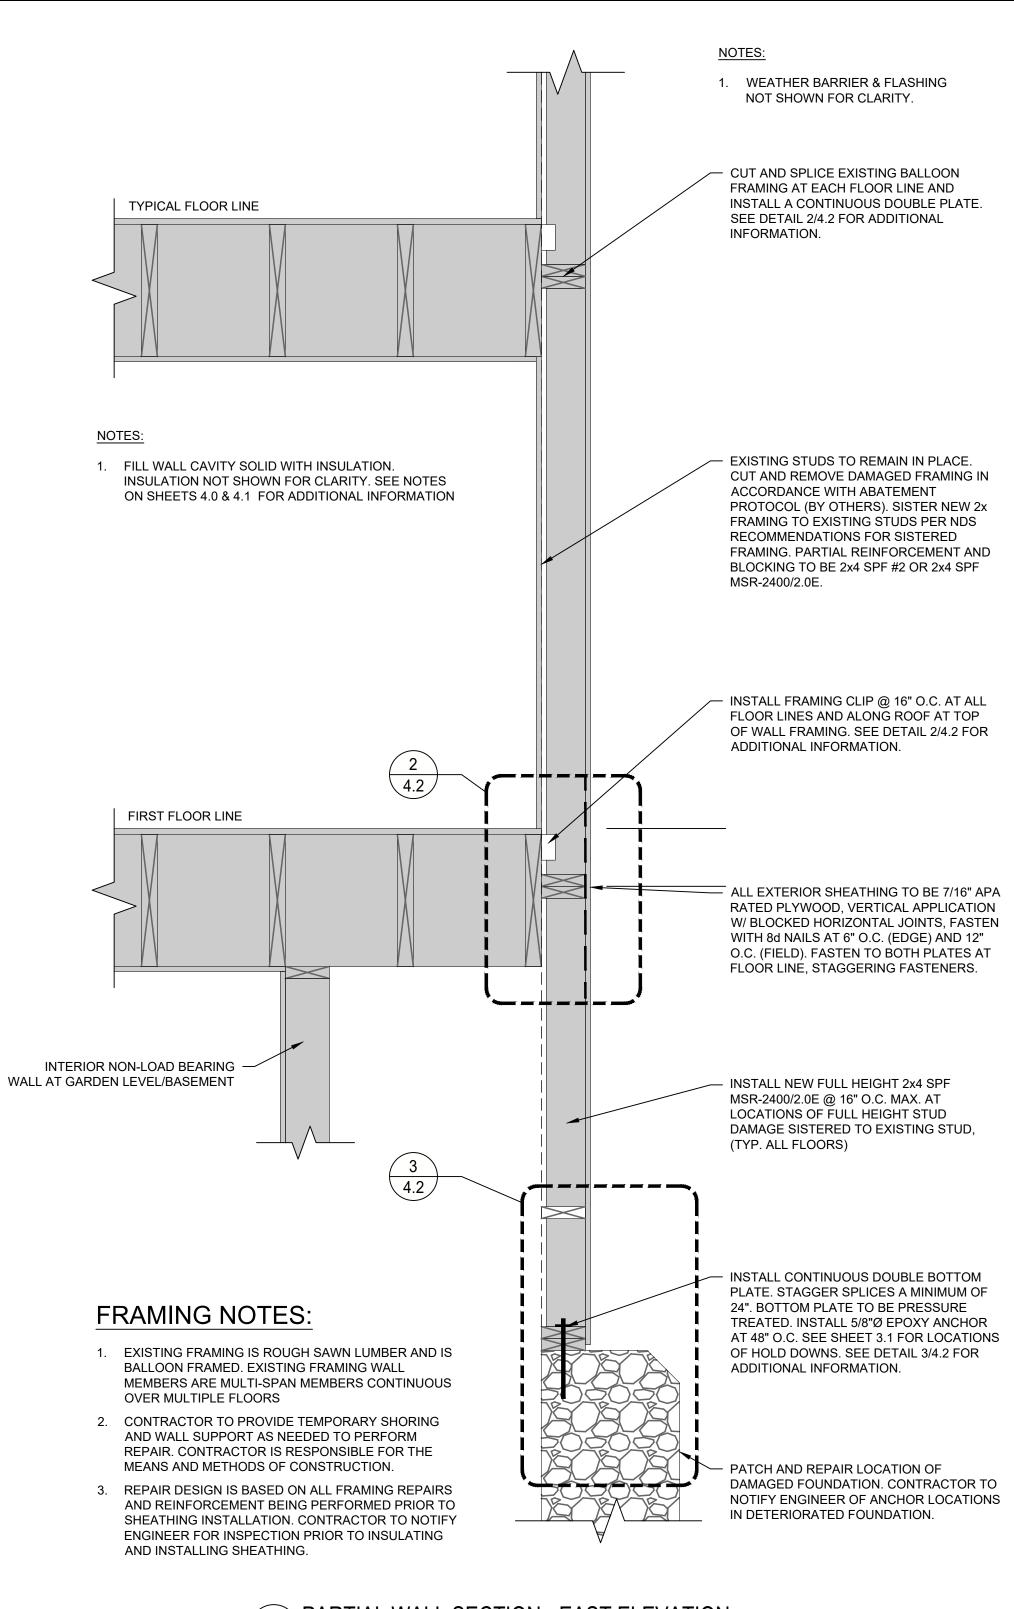

1 PARTIAL WALL SECTION - EAST ELEVATION 4.2 SCALE: 1" = 1'-0"

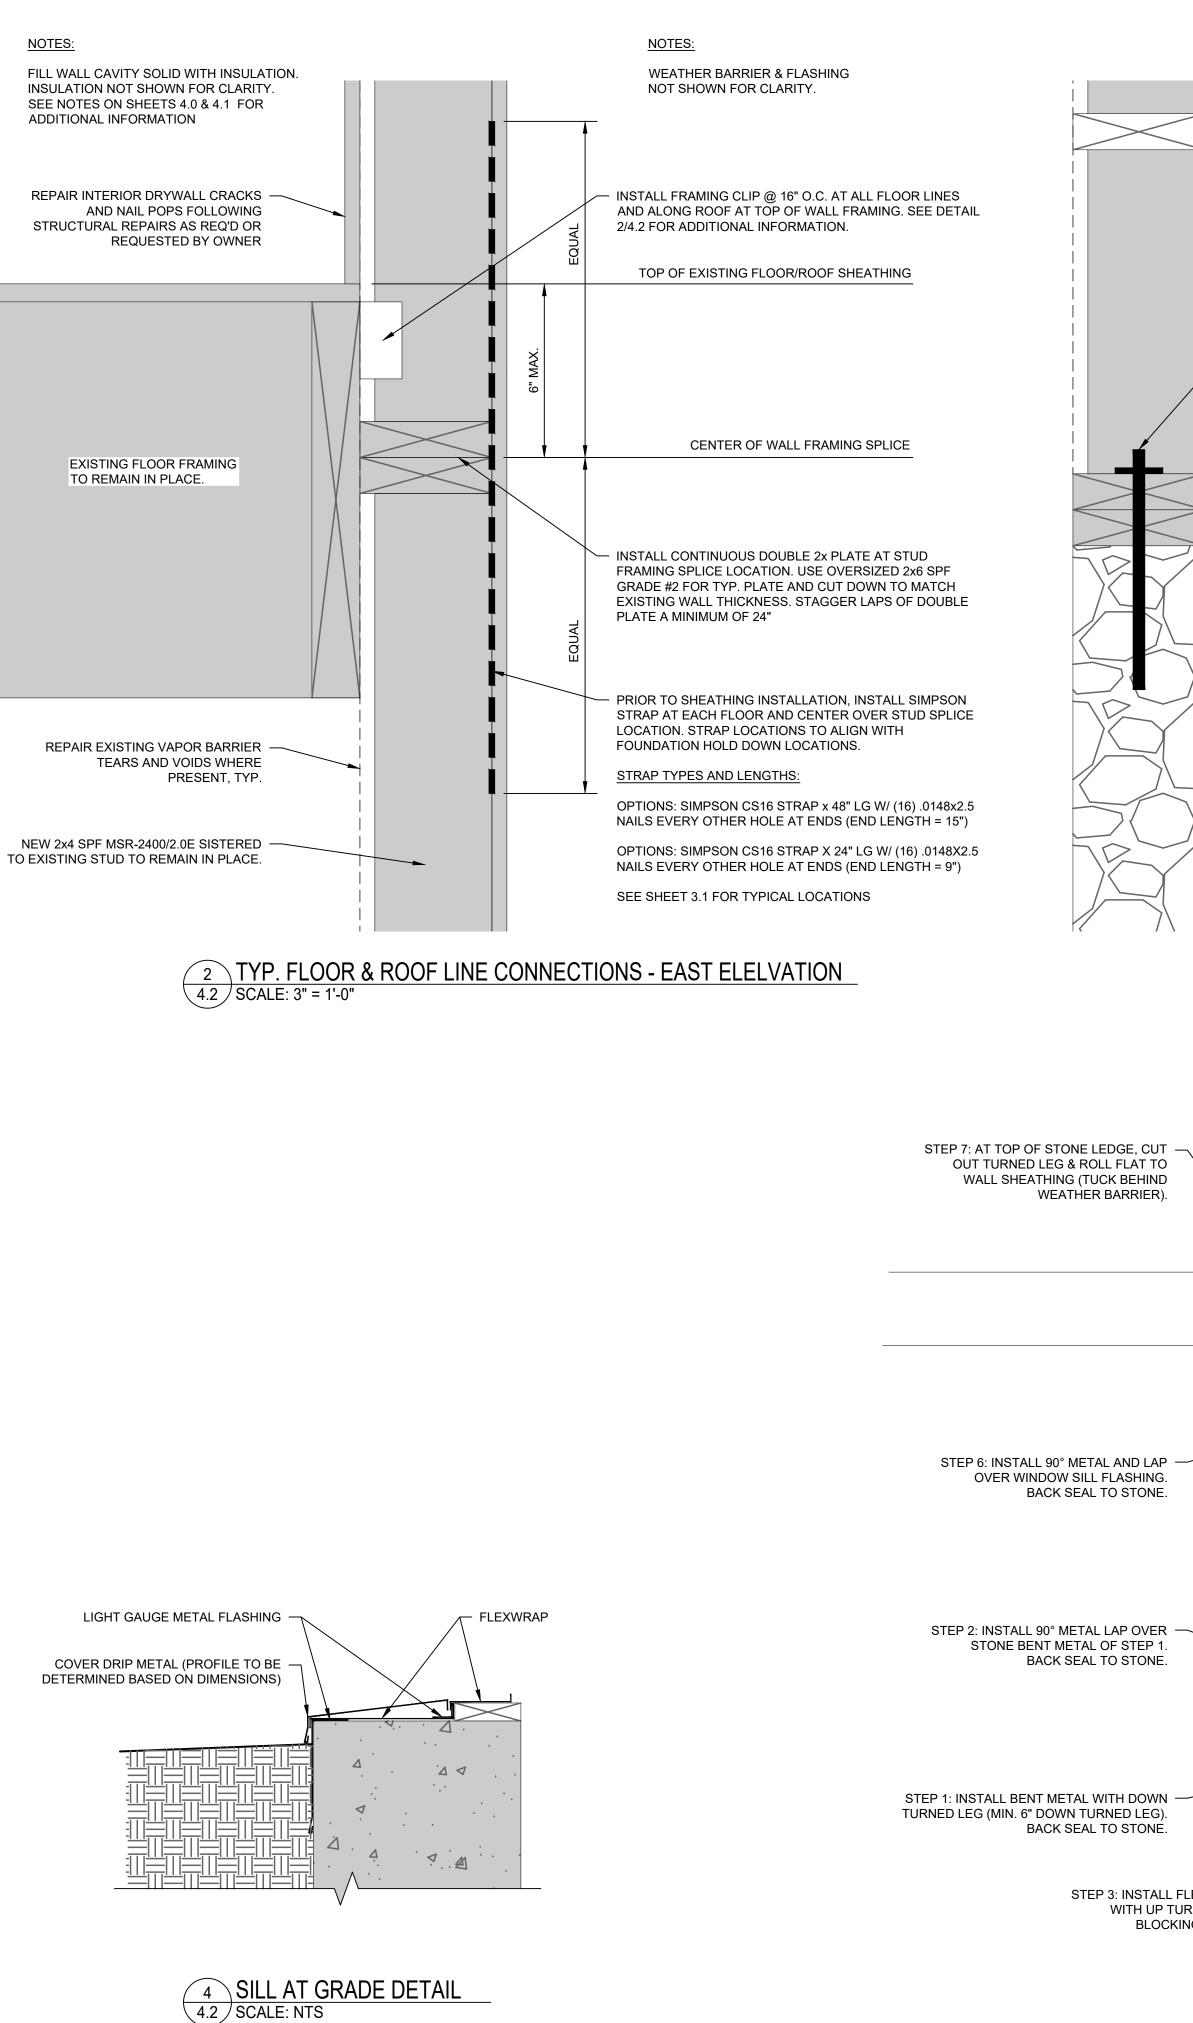

WHERE SHEATHING IS NOT PRESENT AT INTERIOR FACE OF FRAMING AT LOWER LEVEL AND FRAMING HEIGHT EXCEEDS 6'-0", INSTALL 2x4 BLOCKING AT MID-HEIGHT EVERY OTHER STUD SPACE.	Encompass engineering consultants forensic analysis
 INSTALL SIMPSON HD3B HOLD DOWN ANCHOR W/ 5/8"Ø GALVANIZED EPOXY ANCHOR WITH 6" MIN. EMBEDMENT. FASTEN TO DBL 2x POST W/ (2) 5/8"Ø THRU-BOLTS. INSTALL HOLDDOWN PER MANUFACTURER'S RECOMMENDATIONS. 	5435 Feltl Road Minnetonka, MN 55343 Tel: (952) 854-4511 www.encompassinc.com
ALL WOOD IN DIRECT CONTACT WITH CONCRETE, STONE, OR MASONRY TO BE PRESSURE TREATED. HOLD EXTERIOR SHEATHING OFF OF CONCRETE, STONE, OR MASONRY SURFACES A MINIMUM OF 3/8". INSTALL SILL PLATE GASKET OR OTHER APPROVED MEANS TO PROVIDE SEAL BETWEEN BOTTOM PLATE AND EXISTING FOUNDATION WALL. (TYP)	CONSULTANTS:
Image: Note of the second s	CERTIFICATION: I hereby certify that this drawing was prepared by me or under my direct supervision and that I am a duly Licensed Professional Engineer under the laws of the State of Minnesota. Signature Name Date Registration Number
3 TYP. FOUNDATION DETAIL - EAST WALL 4.2 SCALE: 3" = 1'-0" STEP 8: INSTALL JAMB FLASHING TAPE (NOT SHOWN).	Project Number: 22-7311-003 Date: 02/18/2022 Drawn: MDT Checked: MKM Scale: AS NOTED
STEP 5: INSTALL WINDOW SILL ROUGH OPENING FLASHING WITH REAR TURNED UP LEG FOR SILL DAM.	REVISIONS:
	PROJECT: 2022 EXTERIOR FACADE REPAIR PROJECT - PHASE II CITYVIEW CO-OP MINNEAPOLIS, MN
LEXWRAP FLASHING RNED LEG AT WOOD NG AT WINDOW SILL.	SHEET TITLE: DETAILS SHEET NUMBER:
5 SILL AT GRADE 4.2 SCALE: NTS	SHEET NUMBER: