


STRUCTURAL ADDENDUM 05/12/2021

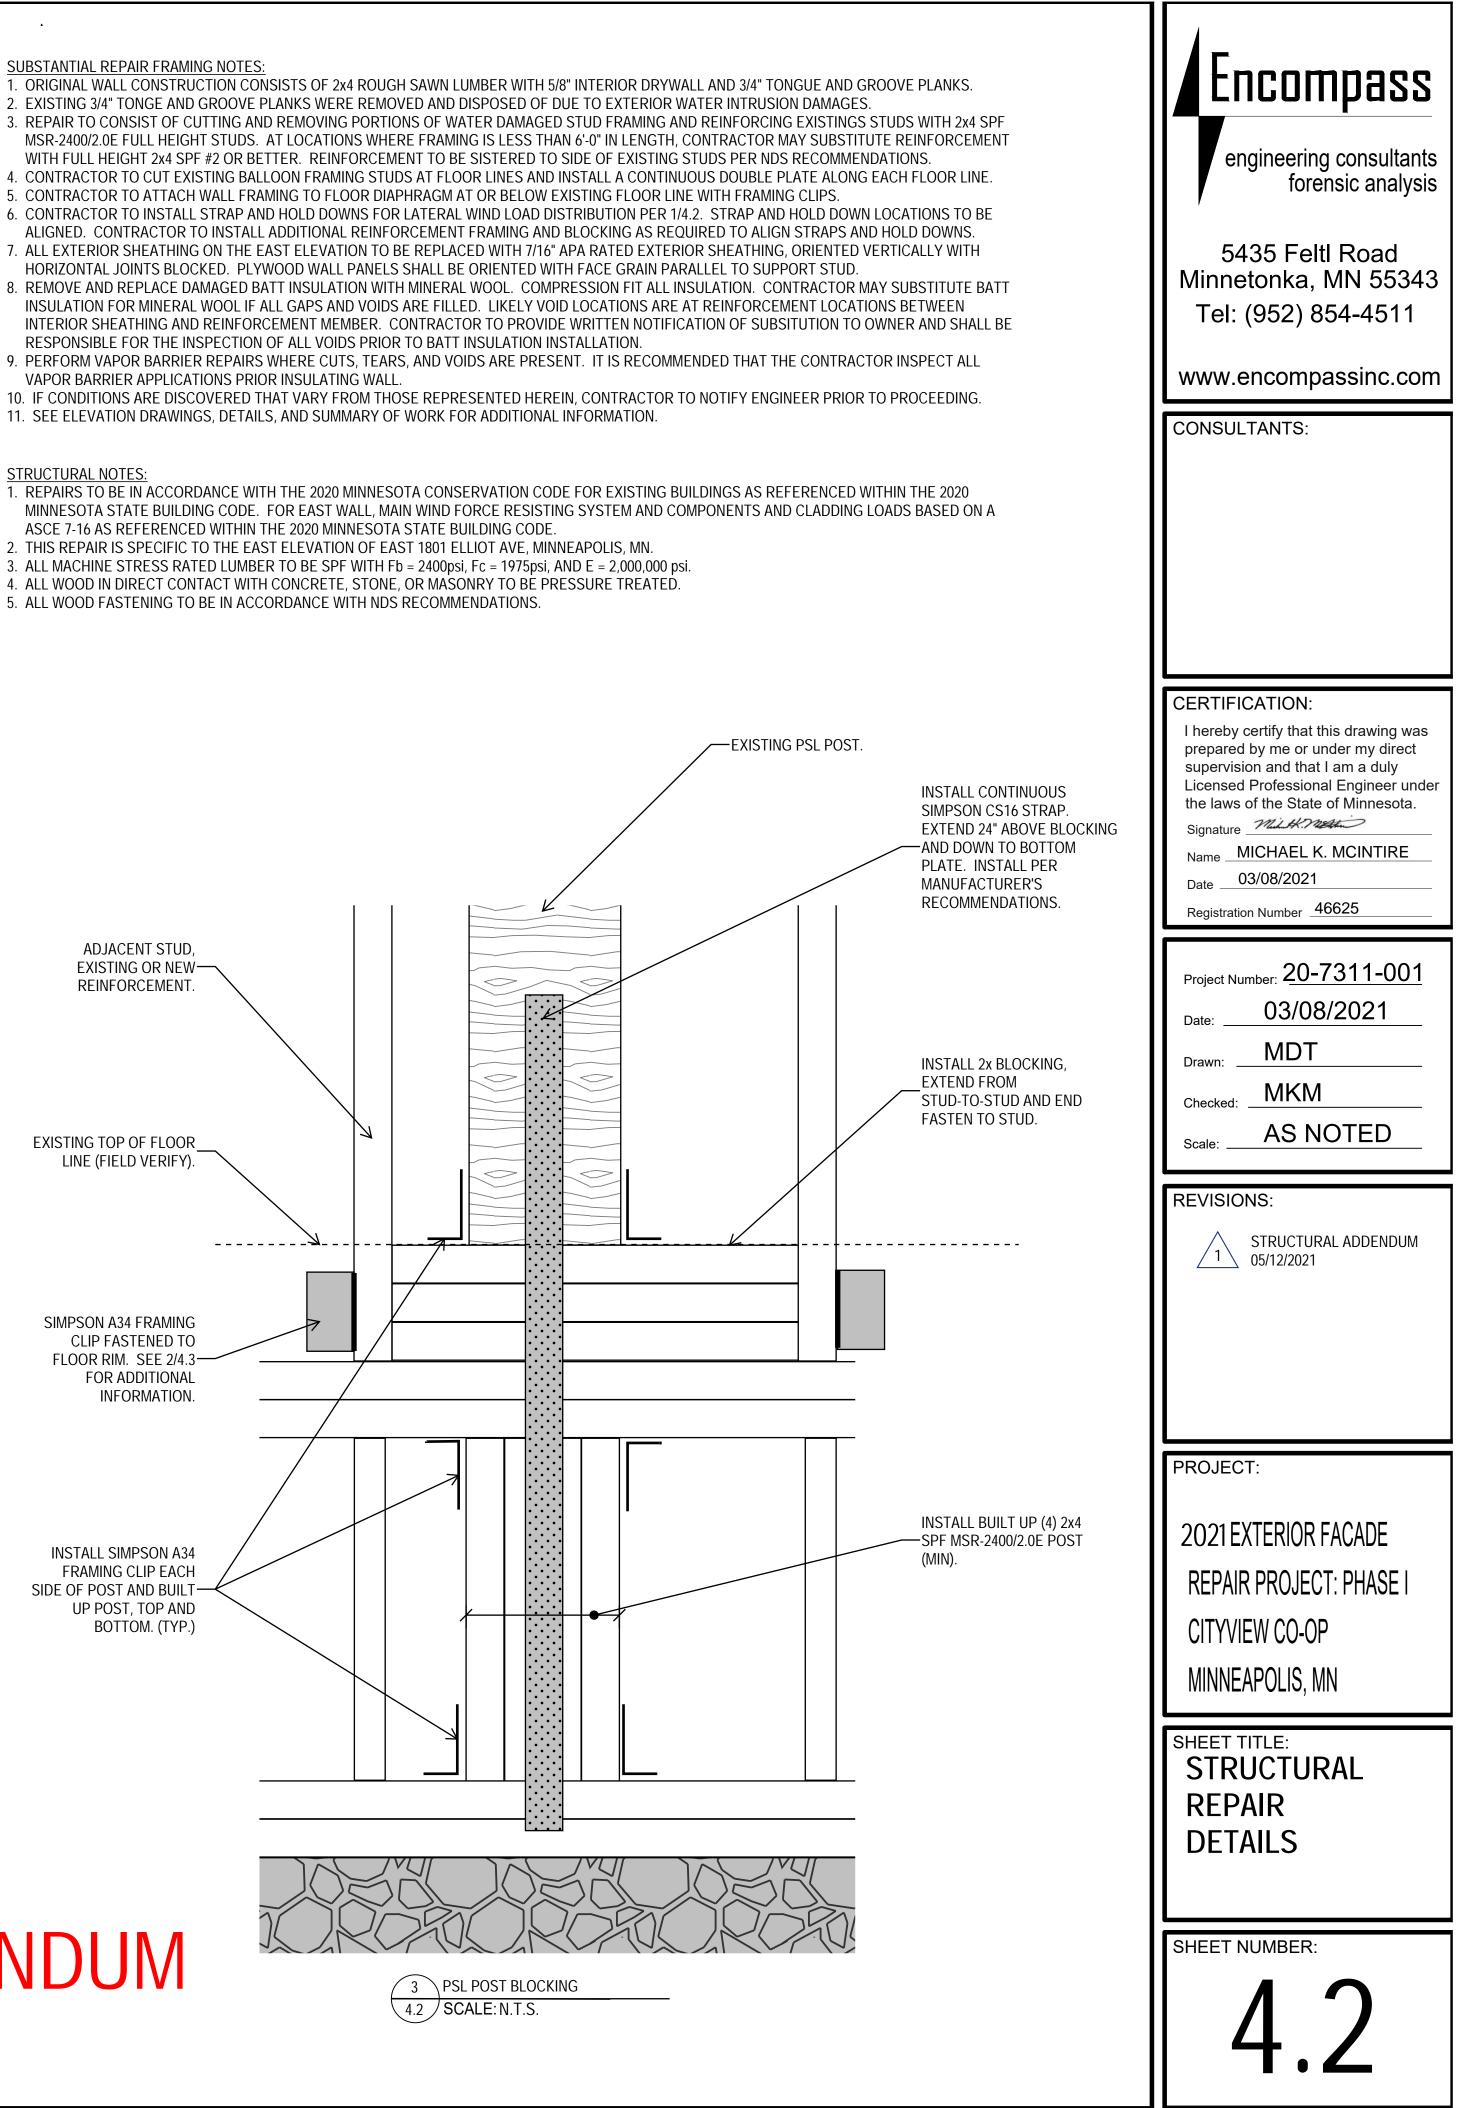

ADJACENT STUD, EXISTING OR NEW-REINFORCEMENT. EXISTING TOP OF FLOOR LINE (FIELD VERIFY). ______ SIMPSON A34 FRAMING CLIP FASTENED TO FLOOR RIM. SEE 2/4.3 FOR ADDITIONAL INFORMATION INSTALL SIMPSON A34 FRAMING CLIP EACH

SIDE OF POST AND BUILT-UP POST, TOP AND


BOTTOM. (TYP.)

2. THIS REPAIR IS SPECIFIC TO THE EAST ELEVATION OF EAST 1801 ELLIOT AVE, MINNEAPOLIS, MN. 3. ALL MACHINE STRESS RATED LUMBER TO BE SPF WITH Fb = 2400psi, Fc = 1975psi, AND E = 2,000,000 psi. 4. ALL WOOD IN DIRECT CONTACT WITH CONCRETE, STONE, OR MASONRY TO BE PRESSURE TREATED. ALL WOOD FASTENING TO BE IN ACCORDANCE WITH NDS RECOMMENDATIONS.

- ASCE 7-16 AS REFERENCED WITHIN THE 2020 MINNESOTA STATE BUILDING CODE
- STRUCTURAL NOTES:
- 11. SEE ELEVATION DRAWINGS, DETAILS, AND SUMMARY OF WORK FOR ADDITIONAL INFORMATION.
- VAPOR BARRIER APPLICATIONS PRIOR INSULATING WALL
- RESPONSIBLE FOR THE INSPECTION OF ALL VOIDS PRIOR TO BATT INSULATION INSTALLATION.

- SUBSTANTIAL REPAIR FRAMING NOTES

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1PARTIAL WALL SECTION - EAST ELEVATION4.3SCALE: N.T.S.

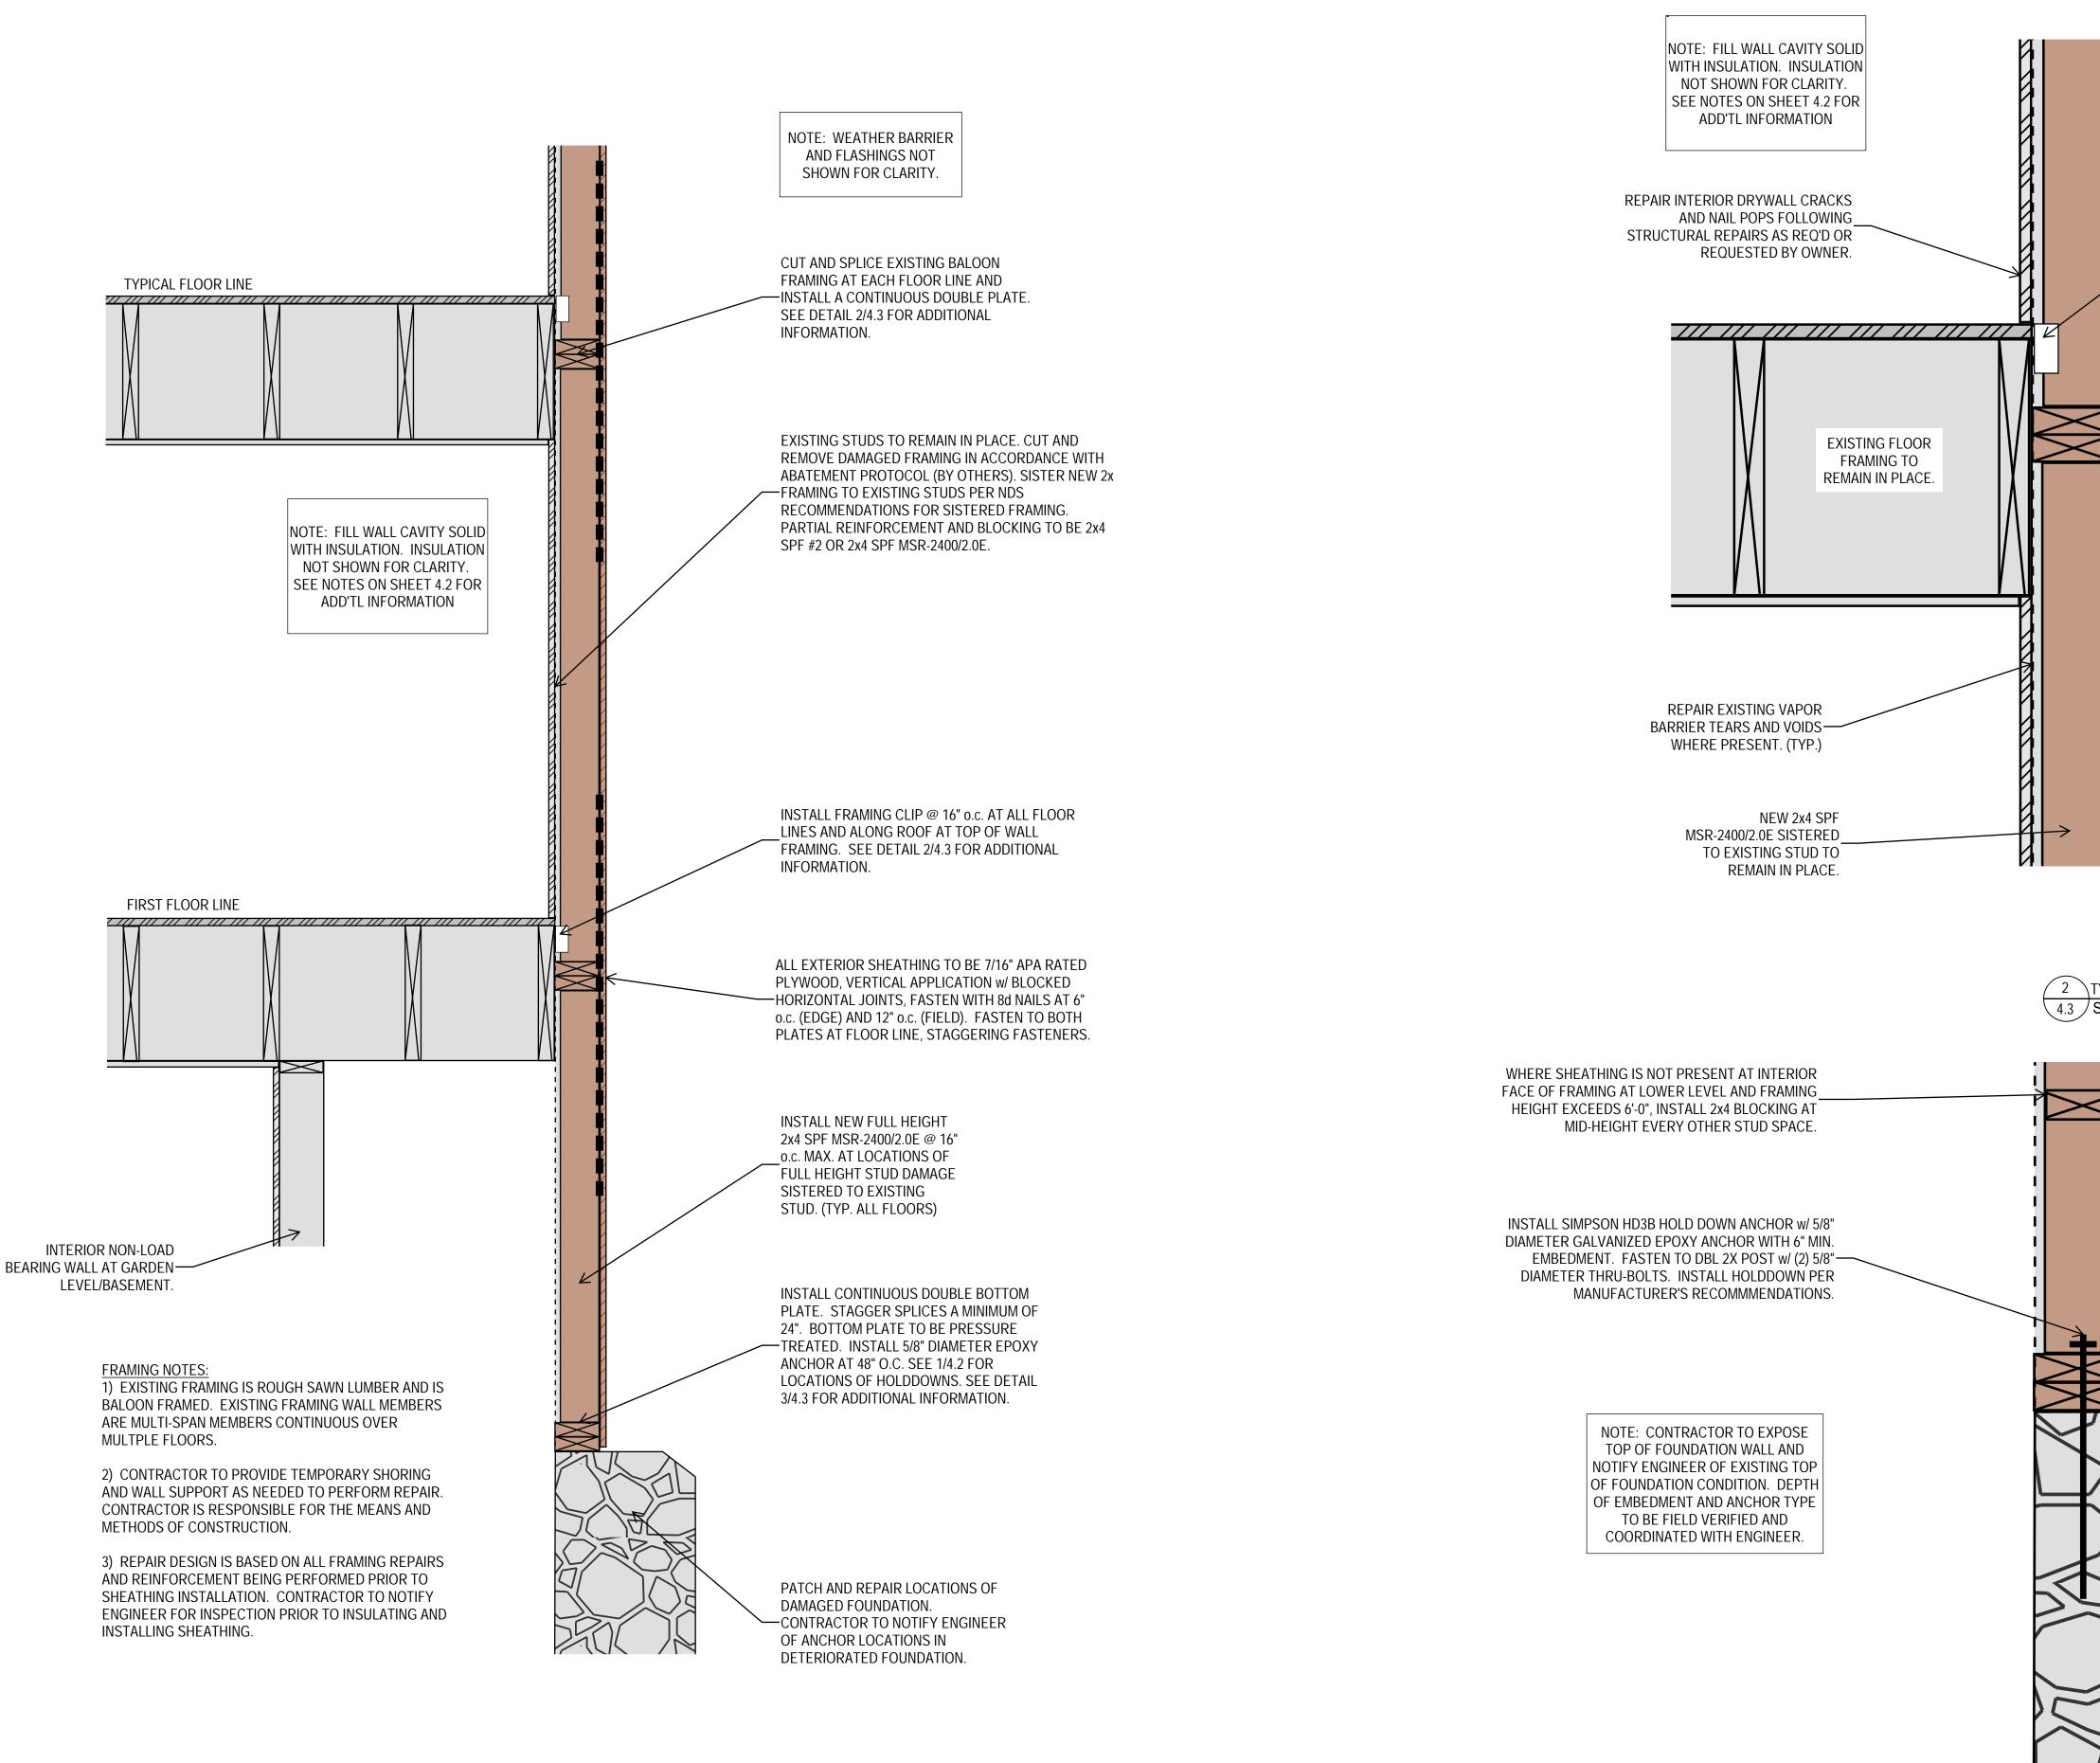STRUCTURAL ADDENDUM 05/12/2021



NOTE: WEATHER BARRIER AND FLASHINGS NOT SHOWN FOR CLARITY. INSTALL SIMPSON A34 FRAMING CLIP AT EACH VERTICAL REINFORCEMENT STUD. FRAMING CLIP TO BE INSTALLED AT OR BELOW EXISTING FLOOR SHEATHING. FASTEN FRAMING CLIP TO EXISTING JOIST AND TO NEW REINFORCEMENT STUD. (TYP) TOP OF EXISTING FLOOR/ROOF SHEATHING	Encompassengineering consultants forensic analysis5435 Feltl Road Minnetonka, MN 55343 Tel: (952) 854-4511www.encompassinc.comCONSULTANTS:
CENTER OF WALL FRAMING SPLICE INSTALL CONTINUOUS DOUBLE 2X PLATE AT STUD FRAMING SPLICE LOCATION. USE OVERSIZED 2x6 SPF GRADE #2 FOR TYPICAL PLATE AND CUT DOWN TO MATCH EXISTING WALL THICKNESS. STAGGER LAPS OF DOUBLE PLATE A MINIMUM OF 24". PRIOR TO SHEATHING INSTALLATION, INSTALL SIMPSON STRAP AT EACH FLOOR AND CENTER OVER STUD SPLICE LOCATION. STRAP COCATIONS TO ALIGN WITH FOUNDATION HOLD DOWN LOCATIONS. STRAP TYPES AND LENGTHS: OPTION: SIMPSON CS16 STRAP X 48" LG w/ (16) 0.148x2.5 NAILS EVERY OTHER HOLE AT ENDS (END LENGTH = 15"). OPTION: SIMPSON CS16 STRAP X 24" LG w/ (16) 0.148x2.5 NAILS EVERY HOLE AT ENDS (END LENGTH = 15"). SEE SHEET 4.2 FOR TYPICAL LOCATIONS YPICAL FLOOR AND ROOF LINE CONNECTIONS - EAST ELEVATION SCALE: N.T.S.	CERTIFICATION: I hereby certify that this drawing was prepared by me or under my direct supervision and that I am a duly Licensed Professional Engineer under the laws of the State of Minnesota. Signature MUCHAEL K. MCINTIRE Date 03/08/2021 Registration Number 46625 MDT Date: 03/08/2021 Date: 03/08/2021 Date: 03/08/2021 Date: 03/08/2021 Date: MDT Drawn: MLT MKM AS NOTED Scale: MS NOTED
WITH CONCRETE, STONE, OR MASONRY TO BE PRESSURE TREATED. HOLD EXTERIOR SHEATHING OFF OF CONCRETE, STONE, OR MASONRY SURFACES A MINIMUM OF 38'. INSTALL SILL PLATE GASKET OR OTHER APPROVED MEANS TO PROVIDE SEAL BETWEEN BOTTOM PLATE AND EXISTING FOUNDATION WALL. (TYP.)	REVISIONS:
PICAL FOUNDATION DETAIL - EAST WALL CALE: N.T.S.	REPAIR DETAILS SHEET NUMBER: 4.3